

1583 CORMACK CRESCENT MISSISSAUGA, ON

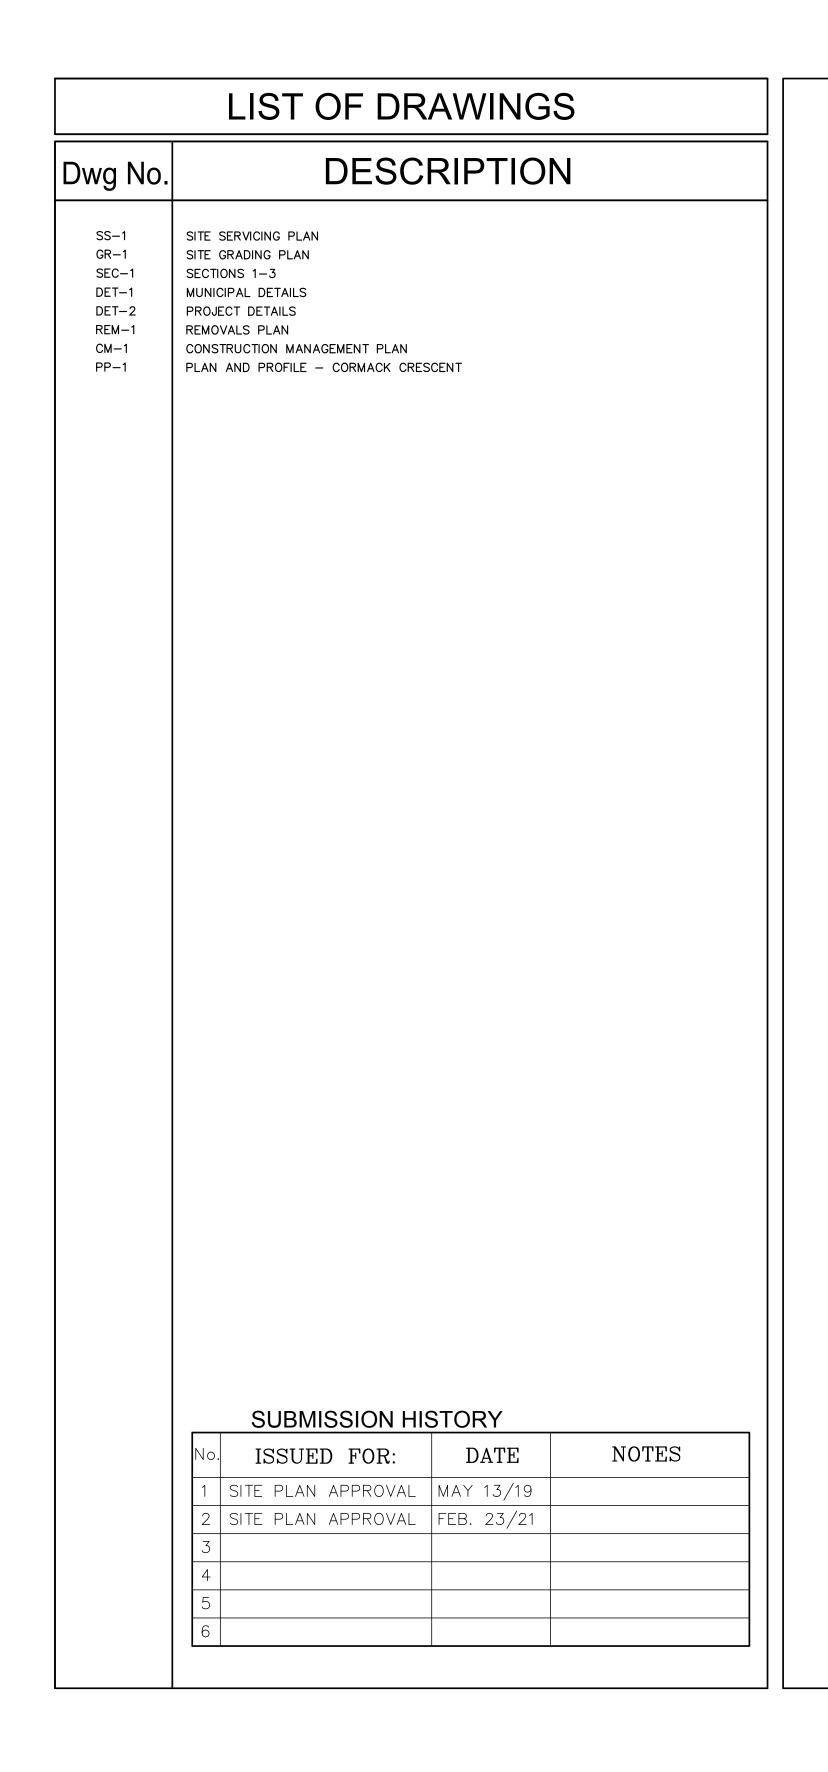

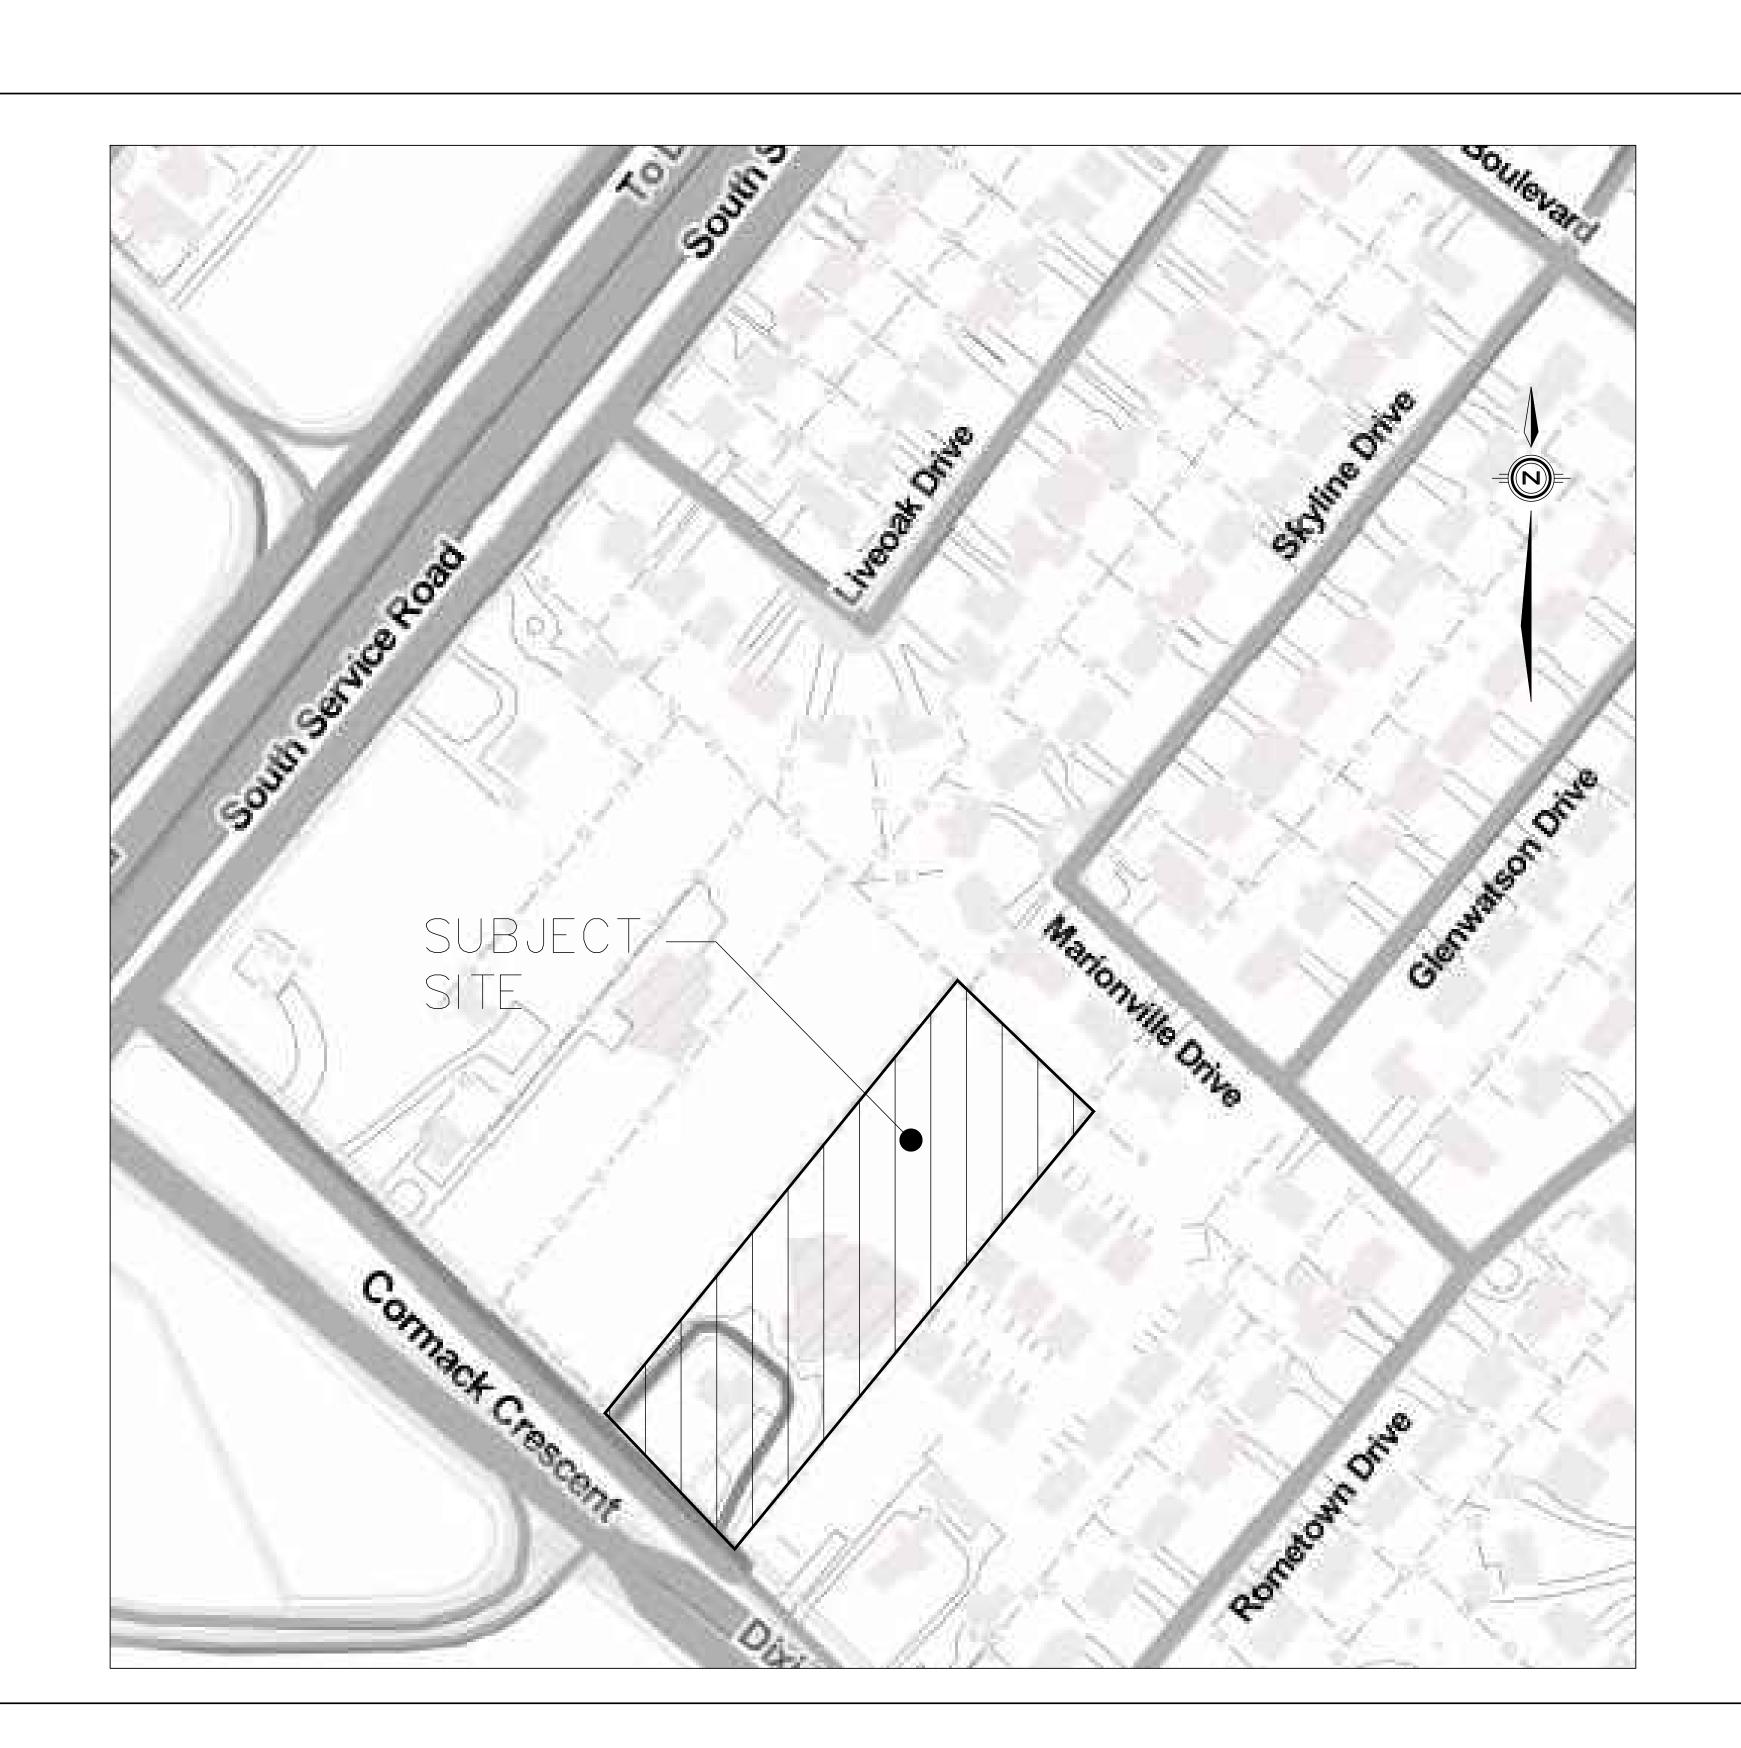


OWNER

ELM CORMACK (2017) INC.

1931 HIGHWAY 7 CONCORD, ONTARIO L4K 1V5

tel.905 709 8232 fax.905 709 8234



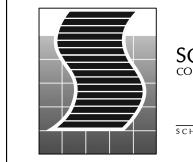

SCHAEFFERS CONSULTING ENGINEERS

Tel: (905) 738-6100



MUNICIPALITY

ENGINEERING DEPARTMENT

REGION



PROJECT No.

2018 - 4679

CITY FILE NO.: 21T-M 19 5 REGION FILE NO.: T-19005Ma

GENERAL NOTES

- 1. ALL CONCRETE AND PLASTIC SEWER PIPE SHALL HAVE RUBBER GASKET JOINTS.
- 2. ALL SEWERS SHALL BE CONSTRUCTED WITH BEDDING IN ACCORDANCE WITH OPSD 802.03 CLASS "B" UNLESS OTHERWISE NOTED.
- 3. PLASTIC SEWER PIPES SHALL BE CONSTRUCTED WITH ULTRA RIB OR APPROVED EQUAL UP TO THE
- 4. ALL WORKS SHALL BE CONSTRUCTED IN ACCORDANCE WITH CURRENT CITY OF MISSISSAUGA AND OPSD
- STANDARD DRAWINGS AND SPECIFICATIONS.

 5. DOUBLE CATCHBASIN LEADS TO BE 300mm UNLESS OTHERWISE NOTED. ALL CATCHBASIN LEADS TO BE
- EITHER C-14-ES MINIMUM OR P.V.C. TYPE S.D.R. 28.
- COMPACTED TO 95% STANDARD PROCTOR DENSITY.
- INVERTS, ELEVATIONS AND EXACT LOCATIONS OF ALL EXISTING UNDERGROUND SERVICES TO BE VERIFIED IN THE FIELD BEFORE COMMENCING ANY WORK.

6. ALL BACKFILL FOR SEWERS, WATERMAINS AND UTILITIES ON PAVED AREAS MUST BE MECHANICALLY

- 8. ALL AREAS DISTURBED DURING CONSTRUCTION TO BE RESTORED TO ORIGINAL CONDITION OR BETTER TO THE SATISFACTION OF THE CITY OF MISSISSAUGA AND REGION OF PEEL.
- 9. GRASSED AREAS TO BE TOPPED WITH 150mm TOPSOIL AND SODDED WITH No.1 NURSERY SOD.
- 10. THE CONTRACTOR SHALL BE RESPONSIBLE FOR CONTROLLING MUD AND DUST ON ALL PUBLIC ROADS TO THE SATISFACTION OF THE CITY AND REGION.

SPECIAL NOTES

PAVEMENT DESIGN - CONDOMINIUM ROAD

PAVEMENT DESIGN - DRIVEWAYS

THICKNESS

250

150

290

PAVEMENT DESIGN PROVIDED ABOVE IS CONSIDERED A MINIMUM STANDARD AND IS SUBJECT TO REVISION
BASED ON SITE-SPECIFIC GEOTECHNICAL RECOMMENDATIONS PROVIDED BY A QUALIFIED CONSULTANT.
THE GRANULAR BASES SHOULD BE COMPACTED TO 100% OF THE MAXIMUM STANDARD PROCTOR DRY DENSITY

PER RECOMMENDATION FROM MISSISSAUGA STANDARD FOR CONDOMINIUM ROAD.

OPS SPECIFICATIONS

OPS SPECIFICATIONS

GRANULAR 'A' OR EQUIVALENT

GRANULAR 'B' OR EQUIVALENT

GRANULAR 'A' OR EQUIVALENT

GRANULAR 'B' OR EQUIVALENT

HL-3

COURSE

SURFACE COURSE

BINDER COURSE

GRANULAR BASE

SURFACE COURSE

BINDER COURSE

GRANULAR BASE

TOTAL DEPTH

GRANULAR SUB-BASE

TOTAL DEPTH

GRANULAR SUB-BASE

- 1. ALL BUILDINGS SHOWN ON THIS PLAN TO BE CONSTRUCTED WITH SUMP PUMPS FOR FOUNDATION DRAINAGE. PUMPS TO BE INSTALLED SUCH THAT DISCHARGE IS DIRECTED TO ADJACENT SURFACE SURROUNDING BUILDINGS, COMPLETE WITH CONCRETE SPLASH PADS. DISCHARGE FROM SUMP PUMPS IS TO BE DIRECTED AWAY FROM ALL NEARBY BUILDING FOUNDATIONS.
- 2. ALL ROAD CB'S AND DCB'S TO BE FITTED WITH CB SHIELD INSERTS, PER DETAIL ON DRAWING DET-2.

REGION OF PEEL NOTES:

- 1. ALL MATERIALS AND CONSTRUCTIONS METHODS MUST CORRESPOND TO THE CURRENT PEEL PUBLIC WORKS STANDARDS AND SPECIFICATIONS.
- 2. WATERMAIN AND/ OR WATER SERVICE MATERIAL UP TO AND INCLUDING 300mm (12") DIAMETER MUST BE POLYVINYL CHLORIDE (PVC), DR18, A.W.W.A. C900-16. SIZE 50mm (2") AND SMALLER MUST BE COPPER, TYPE K SOFT COPPER ASTM B88-49.
- 3. WATERMAIN AND / OR WATER SERVICES ARE TO HAVE A MINIMUM COVER OF 1.7m (5'6") WITH A MINIMUM HORIZONTAL SPACING OF 1.2m (4") FROM THEMSELVES AND ALL OTHER UTILITIES.
- 4. PROVISION FOR FLUSHING LINE PRIOR TO TESTING, ETC. MUST BE PROVIDED WITH AT LEAST A 50mm (2") OUTLET ON 100mm (4") AND LARGER LINES. COPPER LINES ARE TO HAVE FLUSHING POINTS AT THE END, THE SAME SIZE AS THE LINE. THEY MUST ALSO BE HOSED OR PIPED TO ALLOW THE WATER TO DRAIN ONTO A PARKING LOT OR DOWN A DRAIN. ON FIRE LINES, FLUSHING OUTLET TO BE 100mm (4") DIAMETER MINIMUM ON A HYDRANT.
- 5. ALL CURBS STOPS TO BE 3.0m (10') OFF THE FACE OF THE BUILDING UNLESS OTHERWISE NOTED.
- 6. HYDRANT AND VALVE SET TO REGION STANDARD 1-6-1 DIMENSION A AND B, 0.7m (2') AND 0.9m (3') AND TO HAVE PUMPER NOZZLE.
- 7. WATERMAIN TO BE INSTALLED TO GRADES AS SHOWN ON APPROVED SITE PLAN. COPY OF GRADE SHEET MUST BE SUPPLIED TO INSPECTOR PRIOR TO COMMENCEMENT OF WORK, WHERE REQUESTED BY INSPECTOR.
- 8. WATERMAIN MUST HAVE A MINIMUM VERTICAL CLEARANCE OF 0.30m (12") OVER / 0.5m (20") UNDER SEWERS AND ALL OTHERS UTILITIES WHEN CROSSING.
- 9. ALL PROPOSED WATER PIPING MUST BE ISOLATED FROM EXISTING LINES IN ORDER TO ALLOW INDEPENDENT PRESSURE TESTING AND CHLORINATING
- FROM EXISTING SYSTEMS.
- 10. ALL LIVE TAPPING AND OPERATION OF REGION WATER VALVES SHALL BE ARRANGED THROUGH THE REGIONAL INSPECTOR ASSIGNED OR BY CONTACTING THE OPERATIONS AND MAINTENANCE DIVISION.
- 11. ALL PROPOSED WATER PIPING MUST BE ISOLATED THROUGH A TEMPORARY CONNECTION THAT SHALL INCLUDE AN APPROPRIATE CROSS—CONNECTION CONTROL DEVICE, CONSISTENT WITH THE DEGREE OF HAZARD, FOR BACKFLOW PREVENTION OF THE ACTIVE DISTRIBUTION SYSTEM, CONFORMING TO REGION OF PEEL STANDARD 1—7—7 OR 1—7—8.
- 12. LOCATION OF ALL EXISTING UTILITIES IN THE FIELD TO BE ESTABLISHED BY THE CONTRACTOR.
- 13. THE CONTRACTOR(S) SHALL BE SOLELY RESPONSIBLE FOR LOCATES, EXPOSING, SUPPORTING AND PROTECTING OF ALL UNDERGROUND AND OVERHEAD UTILITIES AND STRUCTURES EXISTING AT THE TIME OF CONSTRUCTION IN THE AREA OF THEIR WORK WHETHER SHOWN ON THE PLANS OR NOT AND FOR ALL REPAIRS AND CONSEQUENCES RESULTING FROM DAMAGE TO SAME.
- 14. THE CONTRACTOR(S) SHALL BE SOLELY RESPONSIBLE TO GIVE 72 HOURS WRITTEN NOTICE TO THE UTILITIES PRIOR TO CROSSING SUCH UTILITIES, FOR THE PURPOSE OF INSPECTION BY THE CONCERNED UTILITY. THIS INSPECTION WILL BE FOR THE DURATION OF THE CONSTRUCTION, WITH THE CONTRACTOR RESPONSIBLE FOR ALL COSTS ARISING FROM SUCH INSPECTION.

LEGEND

DENOTES AREA DRAIN / CATCHBASIN
DENOTES CATCHBASIN w/ CB SHIELD INSERT
(REFER TO DETAIL ON DRAWING DET-2)
DENOTES DOUBLE CATCHBASIN

DENOTES DOUBLE CATCHBASIN
DENOTES STORM MANHOLE
DENOTES SANITARY MANHOLE

DENOTES HYDRANT

DENOTES VALVE & BOX / CHAMBER

DENOTES PROPERTY LINE

DENOTES LIMIT OF U/G CONSTRUCTION

DENOTES OGS (OIL GRIT SEPARATOR)

DENOTES SUMP FOR FOUNDATION DRAINAGE TO THE SURFACE
 DENOTES WATER VALVE BOX

1. THE LOCATION OF ALL UNDERGROUND AND ABOVE GROUND UTILITIES AND STRUCTURES IS NOT

NECESSARILY SHOWN ON CONTRACT DRAWINGS, AND WHERE SHOWN THE ACCURACY OF THE

LOCATION AND FLEVATION OF SUCH UTILITIES AND STRUCTURES IS NOT GUARANTEED. PRIOR

2. ALL AREAS DISTURBED DURING CONSTRUCTION OF SEWERS AND WATERMAINS TO BE RESTORED

TO ORIGINAL CONDITION OR BETTER, TO THE SATISFACTION OF THE CITY OF VAUGHAN AND

BE TOPPED WITH 150mm TOPSOIL AND SODDED; OTHERWISE, AREAS TO BE RESTORED WITH 150mm TOPSOIL AND HYDROSEEDED, ALL TO THE SATISFACTION OF THE CITY AND REGION.

3. FOUNDATION DRAINS TO HAVE SUMP PUMP FITTED WITH BACK WATER VALVE AND DISCHARGE

6. EXISTING SEWER INFORMATION SHOWN ON THESE PLANS HAS BEEN OBTAINED FROM LIMITED

RECORD DRAWING INFORMATION PROVIDED BY LOCAL MUNICIPAL AUTHORITIES WHICH MAY BE

PARTIAL OR INCOMPLETE. ANY DEVIATION OBSEREVED ON SITE IS TO BE REPORTED TO THE OWNER AND THEIR CONSULTANT IMMEDIATELY IN ORDER TO CONFIRM ANY REQUIRED DESIGN

PRIOR TO COMMENCING ANY WORK WITHIN THE MUNICIPAL RIGHT OF

WAY, THE CONTRACTOR OR DEVELOPER WILL OBTAIN ALL NECESSARY

ROAD OCCUPANCY PERMITS FROM THE APPLICABLE MUNICIPAL

ALL EXISTING SERVICES TO BE ADJUSTED TO SUIT NEW GRADES.

ONTO THE SURFACE AND DIRECTED TO THE ROAD

4. FOR GENERAL NOTES REFER TO DWG. No. GN-1.

5. FOR SECTION DETAILS, REFER TO DRAWING SEC-1.


REVISIONS.

AUTHORITY.

REGION OF YORK. AREAS WHERE GRASS EXISTS UNDER PREDEVELOPMENT CONDITIONS ARE TO

TO COMMENCING CONSTRUCTION, THE CONTRACTOR SHALL VERIFY EXACT LOCATION AND

ELEVATION OF SUCH UTILITIES AND STRUCTURES AND SHALL ASSUME ALL LIABILITIES OF

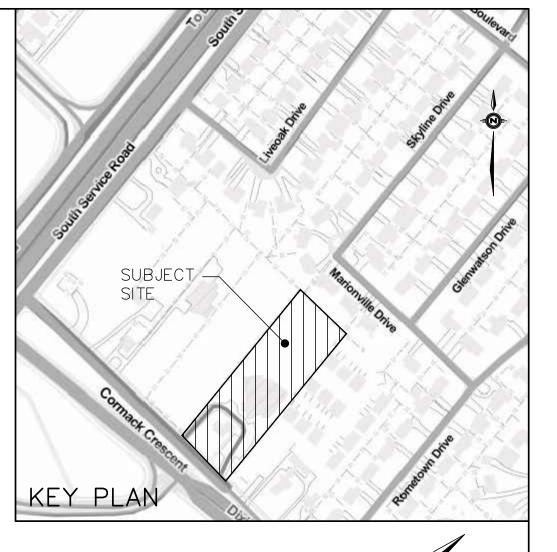



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ELM CORMACK (2017) INC.


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tel. 905 709 8232 fax. 905 709 8234

ONT,

MISSISSAUGA

CITY FILE No.: 21T-M 19 5
REGION FILE No.: T-19005M2
OPOSED CONDO
SITE PLAN
S3 CORMACK CR.

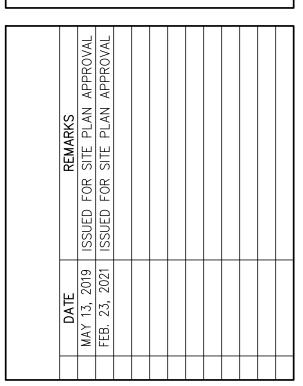

PA / PM:	н.н.т. / н.т.
DRAWN BY:	M.M.
JOB NO.:	4679

SS-1
SERVICING PLAN

SCALE 1: 300

CRESCENT AND HAVE PREPARED THIS PLAN TO INDICATE

ADJACENT PROPERTIES AND MUNICIPAL SERVICES. IT IS MY

BELIEF THAT ADHERANCE TO THE PROPOSED GRADES AS

PROPER FACILITY OF THE MUNICIPAL SERVICES WITHOUT

100130655

FEB. 23, 2021

ELEVATIONS ARE DERIVED FROM CITY OF MISSISSAUGA

104.87m, AND AS PROVIDED ON TOPOGRAPHIC SURVEY

BY J.D. BARNES LTD. (REF. NO. 18-30-305-00-A),

BENCHMARK No. 518, ELEVATION = 106.564m, AND

BASED ON LOCAL BENCHMARK, CUT CROSS ON

SIDEWALK, 1.4m WEST OF SOUTHWEST CORNER OF

PROPERTY CORNER ON DIXIE ROAD, ELEVATION =


DATED NOVEMBER 29, 2018.

ANY DETRIMENTAL EFFECT TO THE EXISTING DRAINAGE

PATTERNS OR ADJACENT PROPERTIES.

SHOWN WILL PRODUCE ADEQUATE SURFACE DRAINAGE AND

THE COMPATIBILITY OF THE PROPOSAL TO EXISTING

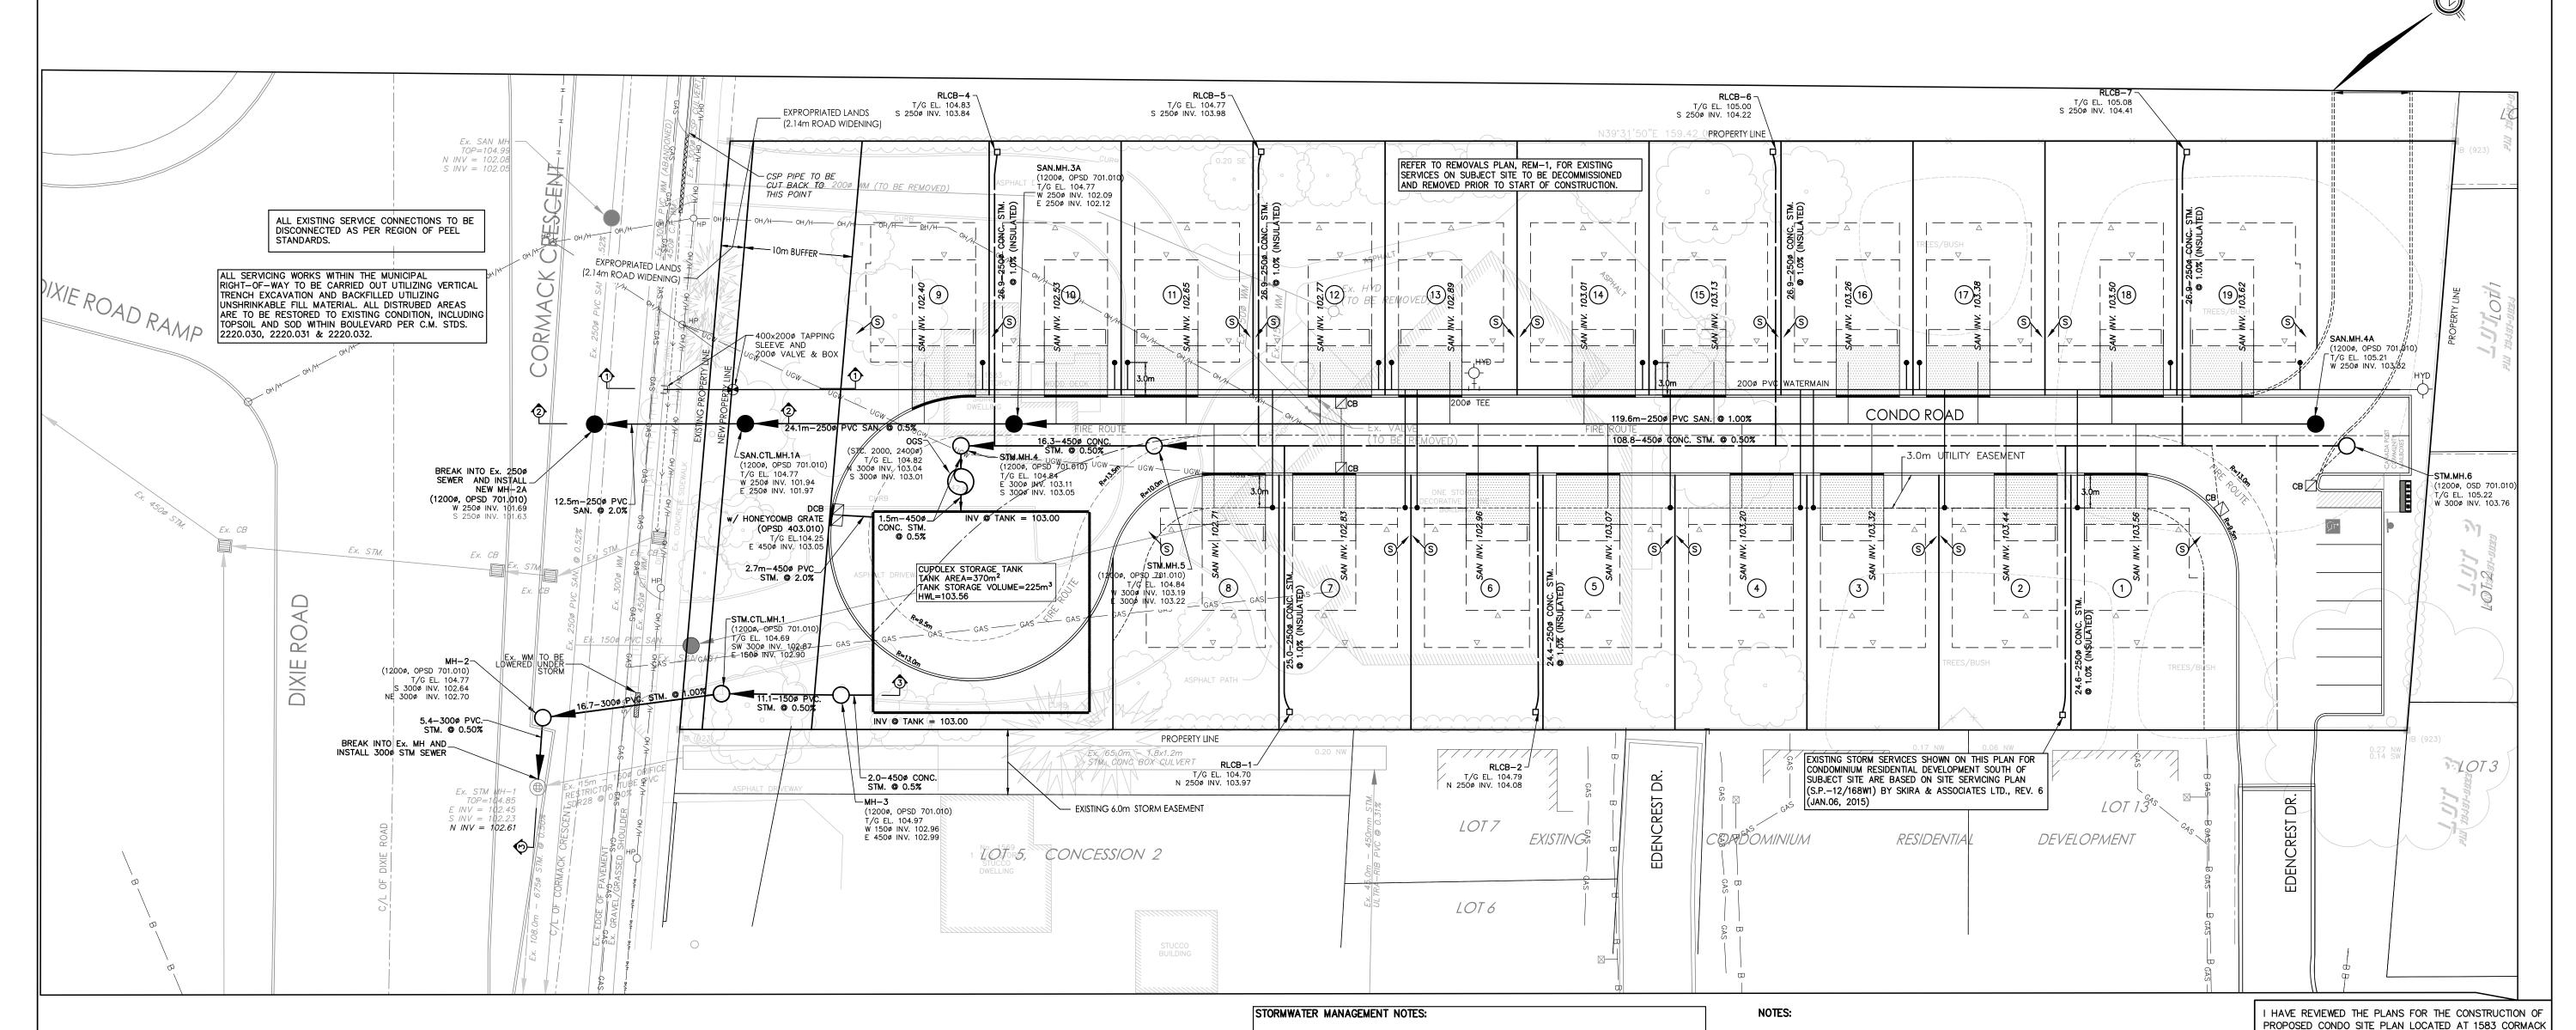

ALL UNITS SHALL BE FITTED WITH FOUR (4) 55gal RAIN BARRELS CONNECTED TO ROOF

MINIMUM 0.3m TOPSOIL DEPTH TO BE PROVIDED IN ALL LANDSCAPE AREAS, AS NOTED IN

DOWNSPOUTS, INCLUDING OVERFLOW TO SPLASH PADS, AS NOTED IN STORMWATER

STORMWATER MAANGEMENT REPORT Y SCHAEFFERS CONSULTING ENGINEERS.

MANAGEMENT REPORT BY SHCAEFFERS CONSULTING ENGINEERS

GENERAL: 1. ALL LOTS (INCLUDING DRAINAGE DITCHES OR SWALES) ARE TO BE SODDED WITH A MINIMUM DEPTH OF

100mm OF TOPSOIL AND No.1 NURSERY SOD, AND THE MINIMUM DEPTH OF 150mm OF CRUSHED STONE TO BE PROVIDED ON THE ENTIRE LENGTH OF EACH DRIVEWAY ON A FIRM SUBGRADE.

2. GRADE ALL AREAS TO:

I) PROVIDE PROPER SURFACE DRAINAGE AND MAXIMIZE USABLE LAND AREA
II) PRESERVE EXISTING TREES WHERE POSSIBLE
III) DIRECT FLOWS AWAY FROM BUILDING

3. MINIMUM YARD SLOPE - 2.00%

4. DRIVEWAY SLOPES:

I) MIN. 2.00% AWAY FROM BUILDINGS

II) PREFERRED MAX. 7.50% (FROM STD.SIDEWALK LOCATION)
III) ABSOLUTE MAX. 1.00%

5. MAXIMUM SLOPE BETWEEN BUILDINGS IN ANY DIRECTION 3:1. USE STEPS AND/OR RETAINING WALLS IF THIS CRITERIA CANNOT BE MET. CONSTRUCT RETAINING WALL WITHIN SIDE LOT LINE.

6. PROVIDE A 0,60m GENTLE SLOPING AREA (2.00% MAX) AWAY FROM THE BUILDING ON AT LEAST ONE SIDE WHERE SIDE YARD SETBACK PERMITS.

7. CLEAR STONE RATHER THAN TOPSOIL AND SOD IS REQUIRED FOR 1.2m OR LESS COMBINED SIDE YARDS BETWEEN TWO BUILDINGS.

RETAINING WALLS:

1. RETAINING WALLS ARE GENERALLY REQUIRED WHERE THE DIFFERENCE IN ELEVATION EXCEEDS 0.60m AND A 3:1 SLOPE CANNOT BE USED BECAUSE OF OTHER FACTORS.

2. CONSTRUCT RETAINING WALLS ENTIRELY ON THE HIGHER LOT SO THAT TIE BACKS DO NOT CROSS PROPERTY BOUNDARIES.

3. CERTIFICATION BY THE CONSULTANT IS REQUIRED ATTESTING TO STRUCTURAL (INTEGRITY, MATERIAL AND TIE BACKS, LINE AND GRADE).

4. A) FENCING WILL BE REQUIRED WHERE WALL HEIGHT EXCEEDS 0.60m

B) SCREEN FENCING, WHERE APPLICABLE, WILL GENERALLY BE PLACED ON TOP OF THE RETAINING WALL. HOWEVER, DUE CONSIDERATION SHOULD BE GIVEN TO THE AESTHETIC IMPACT OF THE COMBINED WALL/FENCE HEIGHT.

5. DETAILS OF WALL OVER 0.60m ARE TO BE SUBMITTED WITH GRADING PLANS AND STAMPED BY A PROFESSIONAL ENGINEER.

DENOTES CATCHBASIN
DENOTES DOUBLE CATCHBASIN
DENOTES STORM MANHOLE
DENOTES SANITARY MANHOLE

DENOTES SANITARY MANHOLE

DENOTES HYDRANT

DENOTES VALVE & BOX

DENOTES LIMIT OF DEVELOPMENT

199.80 DENOTES PROPOSED ELEVATION

DENOTES EXISTING CONTOUR

DENOTES EXISTING CONTOUR

199.14 DENOTES EXISTING ELEVATION

DENOTES OVERLAND FLOW ROUTE

DENOTES BARRIER CURB PER OPSD 600.110


DENOTES DEPRESSED BARRIER CURB PER OPSD 600.060


DENOTES WATER VALVE BOX

 DENOTES PROPOSED BOTTOM OF SWALE ELEVATION

DENOTES CUT-OFF SWALE

4.0%
DENOTES PROPOSED GRADE

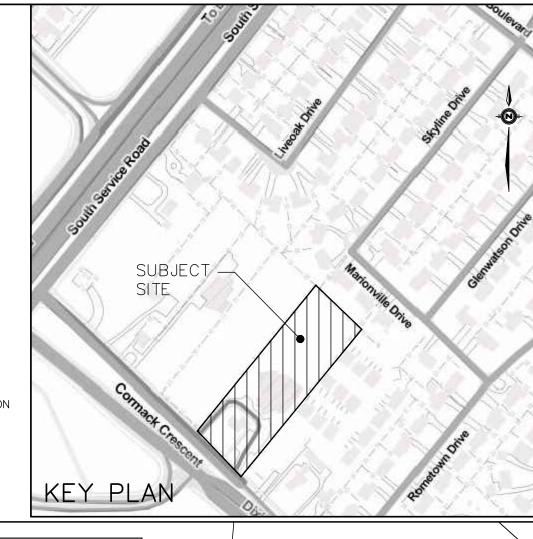

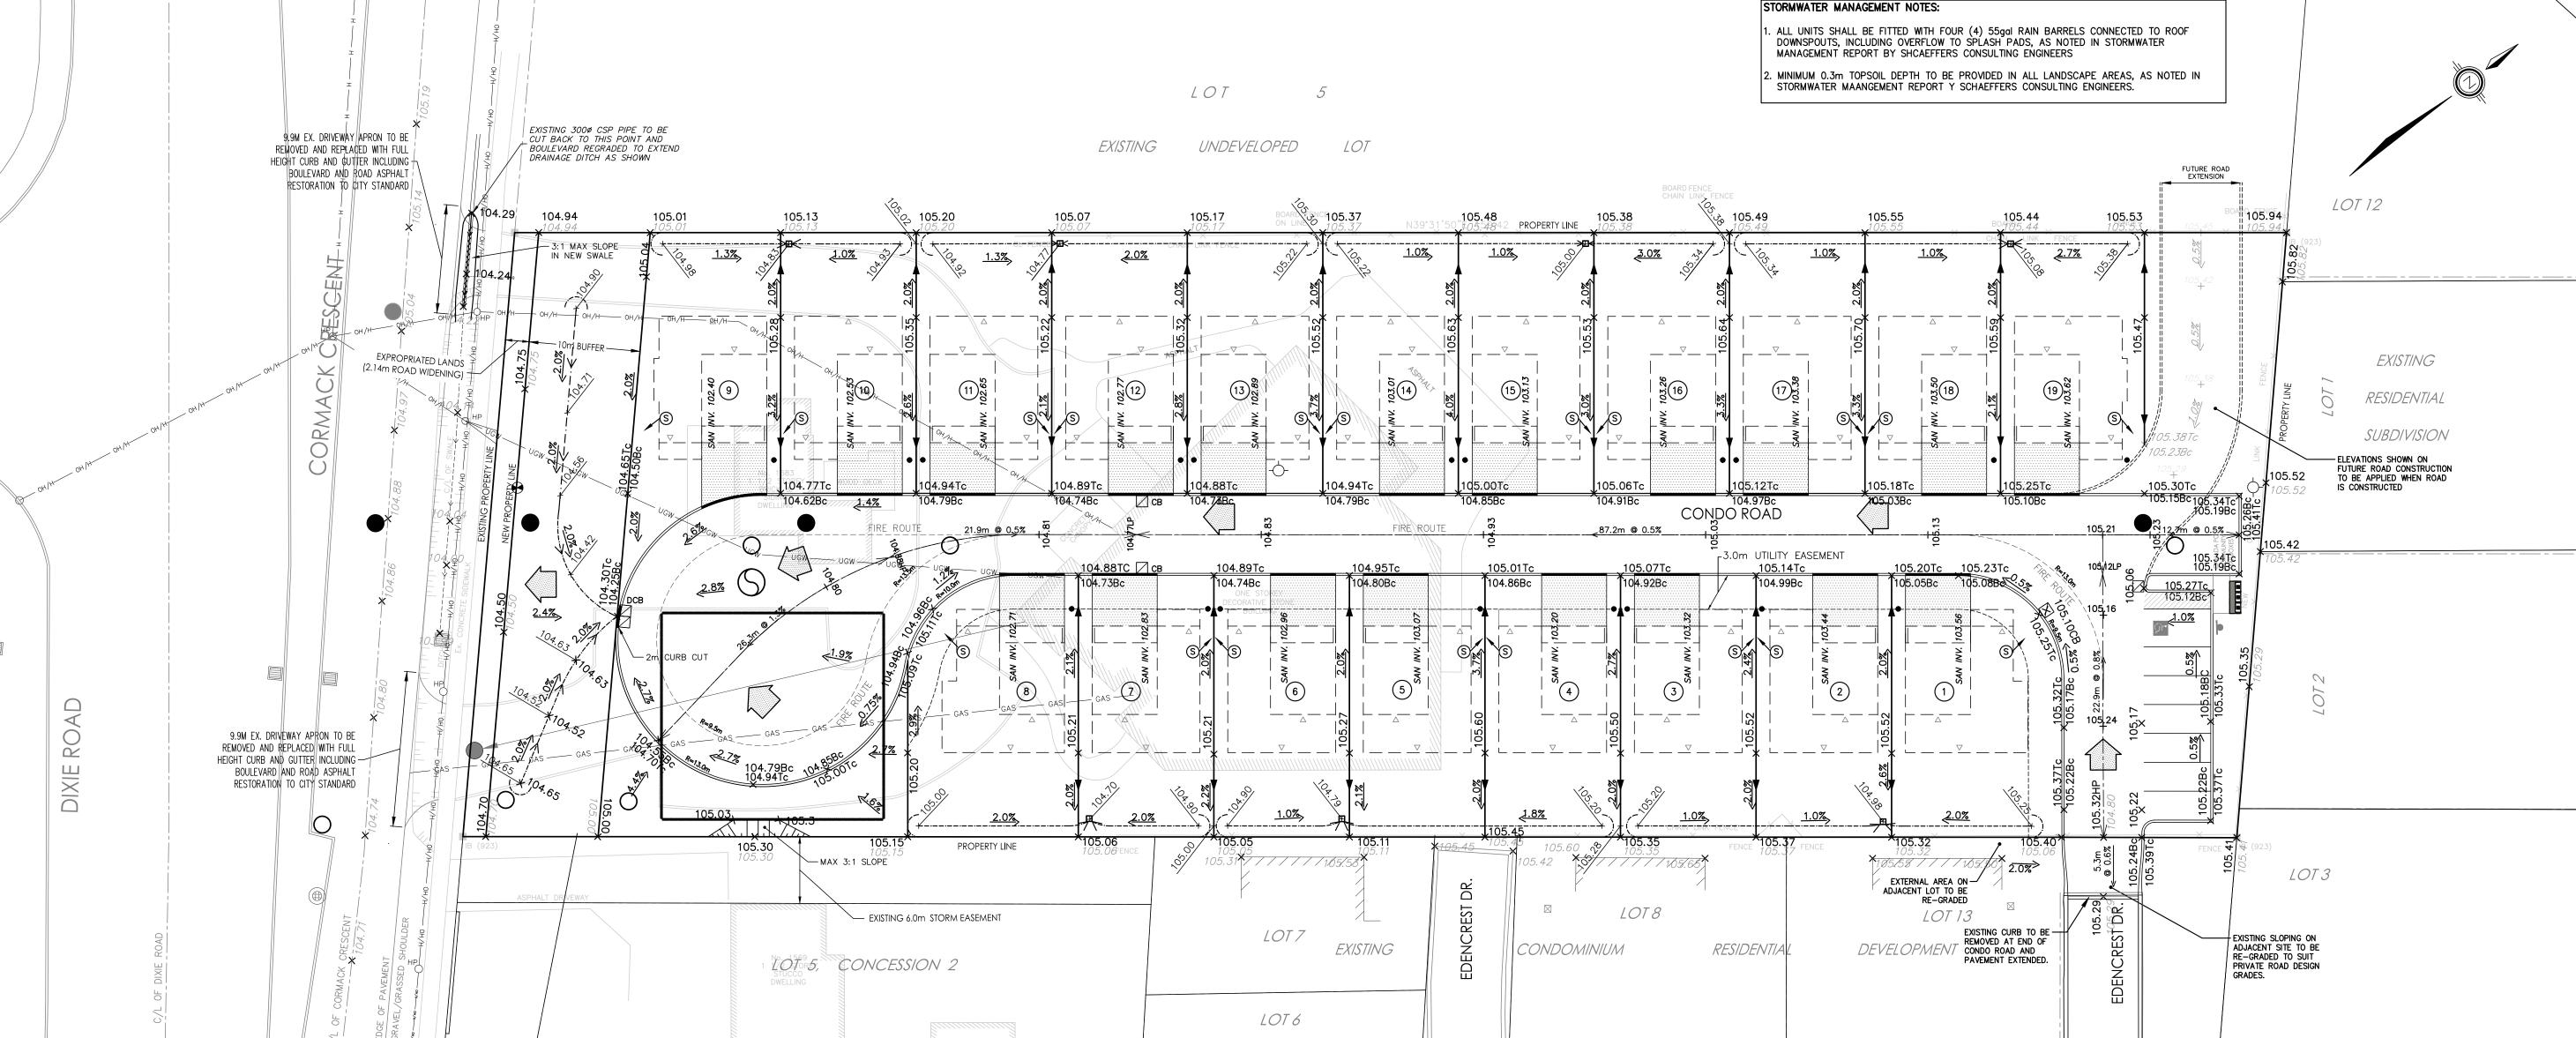

PER RECOMMENDATION FROM N	THICKNESS (mm)	OPS SPECIFICATIONS
SURFACE COURSE BINDER COURSE GRANULAR BASE GRANULAR SUB-BASE TOTAL DEPTH	40 65 200 250 290	HL-3 HL-8 GRANULAR 'A' OR EQUIVALENT GRANULAR 'B' OR EQUIVALENT
		CONDOMINIUM ROAD.
		CONDOMINIUM ROAD. OPS SPECIFICATIONS
PER RECOMMENDATION FROM N	THICKNESS	
SURFACE COURSE BINDER COURSE	THICKNESS (mm) 25 50	OPS SPECIFICATIONS HL-3 HL-8
PER RECOMMENDATION FROM N COURSE SURFACE COURSE	THICKNESS (mm)	OPS SPECIFICATIONS HL-3 HL-8 GRANULAR 'A' OR EQUIVALENT
PER RECOMMENDATION FROM N COURSE SURFACE COURSE BINDER COURSE	THICKNESS (mm) 25 50	OPS SPECIFICATIONS HL-3 HL-8

PAVEMENT DESIGN PROVIDED ABOVE IS CONSIDERED A MINIMUM STANDARD AND IS SUBJECT TO REVISION
BASED ON SITE-SPECIFIC GEOTECHNICAL RECOMMENDATIONS PROVIDED BY A QUALIFIED CONSULTANT.

THE GRANULAR BASES SHOULD BE COMPACTED TO 100% OF THE MAXIMUM STANDARD PROCTOR DRY DENSITY

NOTES:

1. THE LOCATION OF ALL UNDERGROUND AND ABOVE GROUND UTILITIES AND STRUCTURES IS NOT NECESSARILY SHOWN ON CONTRACT DRAWINGS, AND WHERE SHOWN THE ACCURACY OF THE LOCATION AND ELEVATION OF SUCH UTILITIES AND STRUCTURES IS NOT GUARANTEED. PRIOR TO COMMENCING CONSTRUCTION, THE CONTRACTOR SHALL VERIFY EXACT LOCATION AND ELEVATION OF SUCH UTILITIES AND STRUCTURES AND SHALL ASSUME ALL LIABILITIES OF

2. ALL AREAS DISTURBED DURING CONSTRUCTION OF SEWERS AND WATERMAINS TO BE RESTORED TO ORIGINAL CONDITION OR BETTER, TO THE SATISFACTION OF THE CITY OF VAUGHAN AND REGION OF YORK. AREAS WHERE GRASS EXISTS UNDER PREDEVELOPMENT CONDITIONS ARE TO BE TOPPED WITH 150mm TOPSOIL AND SODDED; OTHERWISE, AREAS TO BE RESTORED WITH 150mm TOPSOIL AND HYDROSEEDED, ALL TO THE SATISFACTION OF THE CITY AND REGION. ALL EXISTING SERVICES TO BE ADJUSTED TO SUIT NEW GRADES.

3. FOR GENERAL NOTES REFER TO DWG. No. GN-1.

4. EXISTING SEWER INFORMATION SHOWN ON THESE PLANS HAS BEEN OBTAINED FROM LIMITED RECORD DRAWING INFORMATION PROVIDED BY LOCAL MUNICIPAL AUTHORITIES WHICH MAY BE PARTIAL OR INCOMPLETE. ANY DEVIATION OBSEREVED ON SITE IS TO BE REPORTED TO THE OWNER AND THEIR CONSULTANT IMMEDIATELY IN ORDER TO CONFIRM ANY REQUIRED DESIGN REVISIONS.

PRIOR TO COMMENCING ANY WORK WITHIN THE MUNICIPAL RIGHT OF WAY, THE CONTRACTOR OR DEVELOPER WILL OBTAIN ALL NECESSARY ROAD OCCUPANCY PERMITS FROM THE APPLICABLE MUNICIPAL AUTHORITY.

ELEVATIONS ARE DERIVED FROM CITY OF MISSISSAUGA BENCHMARK No. 518, ELEVATION = 106.564m, AND BASED ON LOCAL BENCHMARK, CUT CROSS ON SIDEWALK, 1.4m WEST OF SOUTHWEST CORNER OF PROPERTY CORNER ON DIXIE ROAD, ELEVATION = 104.87m, AND AS PROVIDED ON TOPOGRAPHIC SURVEY BY J.D. BARNES LTD. (REF. NO. 18-30-305-00-A), DATED NOVEMBER 29, 2018.

HAVE REVIEWED THE PLANS FOR THE CONSTRUCTION OF

PROPOSED CONDO SITE PLAN LOCATED AT 1583 CORMACK CRESCENT AND HAVE PREPARED THIS PLAN TO INDICATE

ADJACENT PROPERTIES AND MUNICIPAL SERVICES. IT IS MY

BELIEF THAT ADHERANCE TO THE PROPOSED GRADES AS

SHOWN WILL PRODUCE ADEQUATE SURFACE DRAINAGE AND

PROPER FACILITY OF THE MUNICIPAL SERVICES WITHOUT ANY DETRIMENTAL EFFECT TO THE EXISTING DRAINAGE

100130655

PATTERNS OR ADJACENT PROPERTIES.

THE COMPATIBILITY OF THE PROPOSAL TO EXISTING




ELM CORMACK (2017) INC.

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tel. 905 709 8232 fax. 905 709 8234


CITY FILE No.: 21T-M 19 5
REGION FILE No.: T-19005N
PROPOSED CONDO
SITE PLAN
1583 CORMACK CR.
MISSISSAUGA, ONTARIO

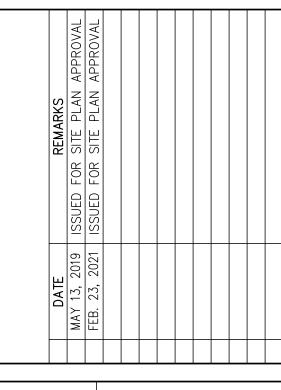



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DRAWN BY:	M.M.
JOB NO.:	4679

GR-1 GRADING PLAN


SCALE 1:300

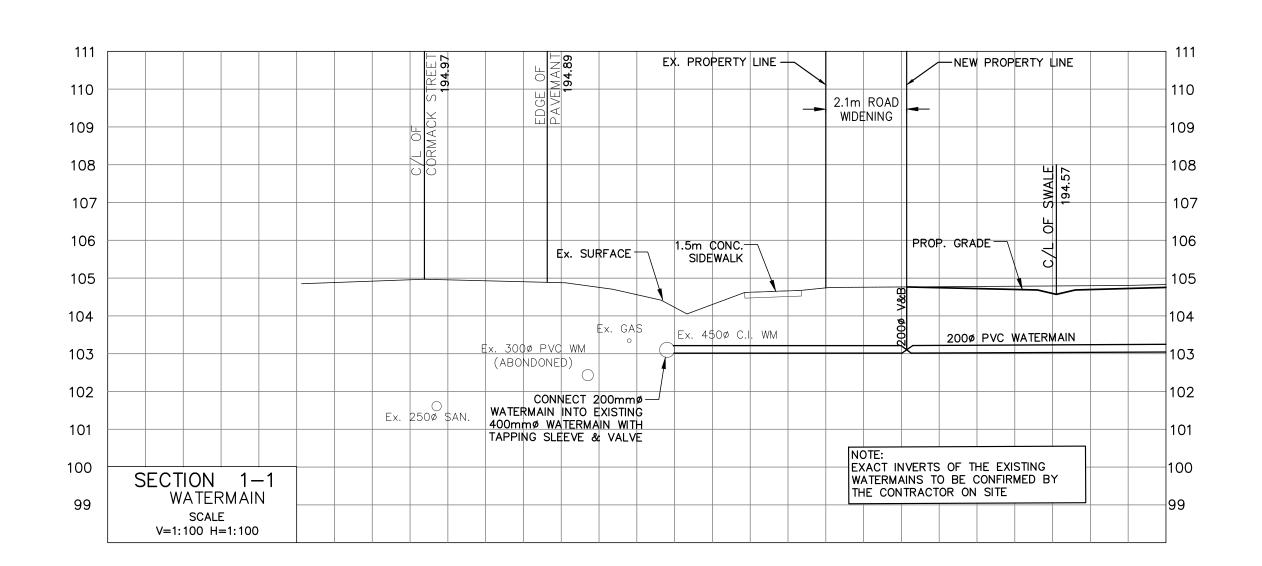

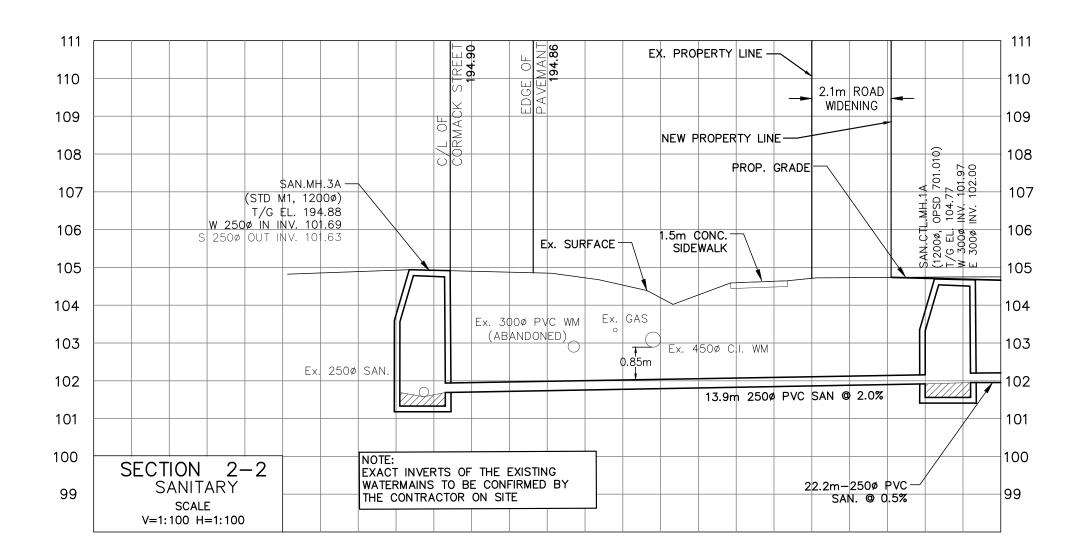

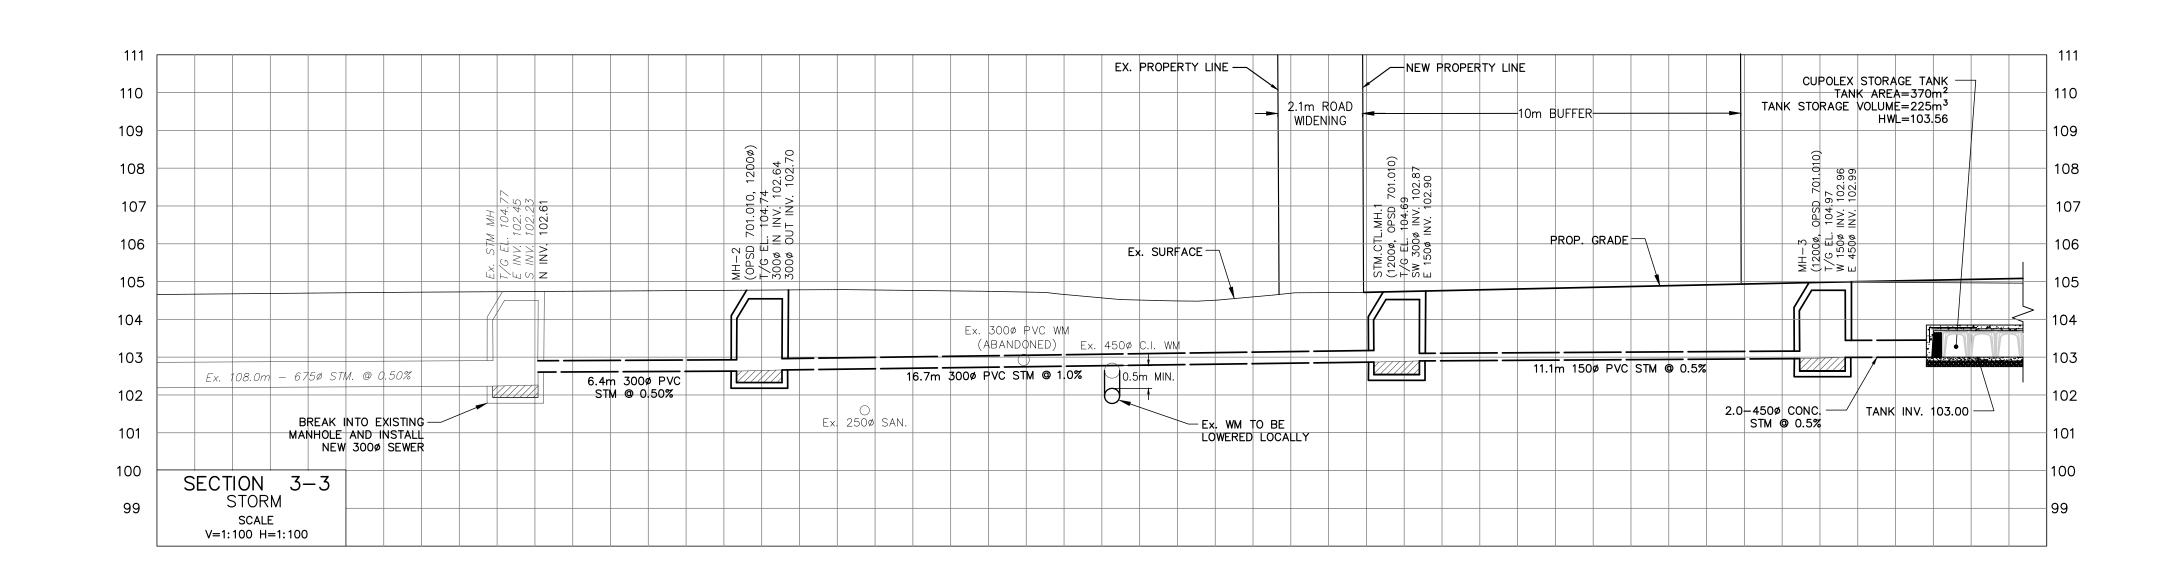

PRIOR TO COMMENCING ANY WORK WITHIN THE MUNICIPAL RIGHT OF WAY, THE CONTRACTOR OR DEVELOPER WILL OBTAIN ALL NECESSARY ROAD OCCUPANCY PERMITS FROM THE APPLICABLE MUNICIPAL

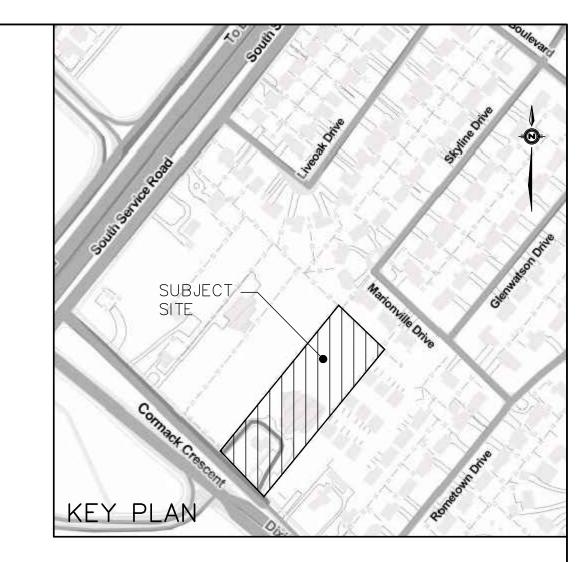



design@schaeffers.com

6 Ronrose Drive, Concord, Ontario L4K 4R3 Tel: (905) 738-6100 Fax: (905) 738-6875

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> tel. 905 709 8232 fax. 905 709 8234

> > ONTARIO


MISSISSAUGA,

CITY FILE No.: 21T-M 19 5
REGION FILE No.: T-19005M

DPOSED CONDO

SITE PLAN CR

ORMACK 1583

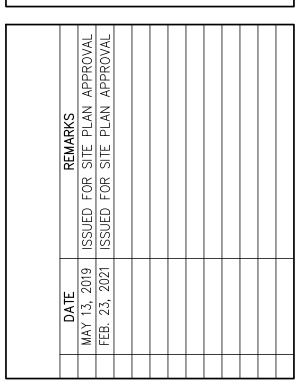

I HAVE REVIEWED THE PLANS FOR THE CONSTRUCTION OF

PROPOSED CONDO SITE PLAN LOCATED AT 1583 CORMACK CRESCENT AND HAVE PREPARED THIS PLAN TO INDICATE

ADJACENT PROPERTIES AND MUNICIPAL SERVICES. IT IS MY

BELIEF THAT ADHERANCE TO THE PROPOSED GRADES AS

SHOWN WILL PRODUCE ADEQUATE SURFACE DRAINAGE AND

100130655

ELEVATIONS ARE DERIVED FROM CITY OF MISSISSAUGA

BY J.D. BARNES LTD. (REF. NO. 18-30-305-00-A),

DATED NOVEMBER 29, 2018.

PROPER FACILITY OF THE MUNICIPAL SERVICES WITHOUT

ANY DETRIMENTAL EFFECT TO THE EXISTING DRAINAGE

PATTERNS OR ADJACENT PROPERTIES.


THE COMPATIBILITY OF THE PROPOSAL TO EXISTING


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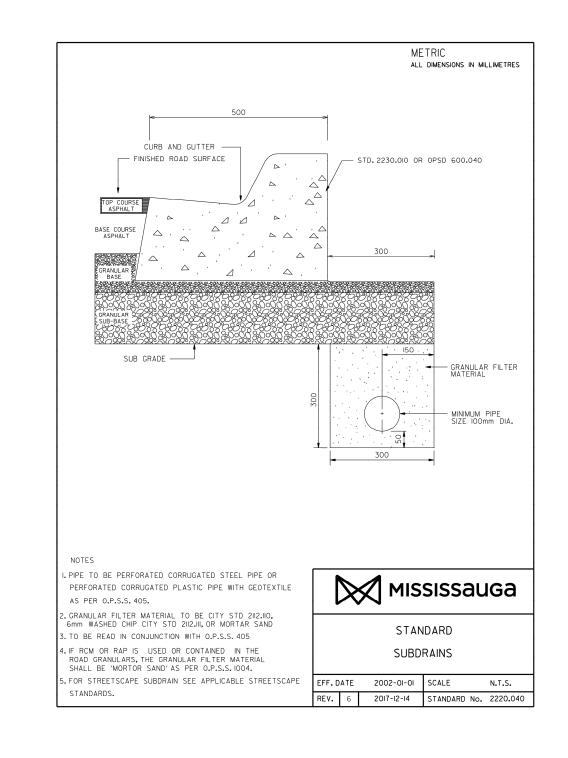
SHEET SEC-1 **CROSS SECTIONS**


SCALE AS SHOWN

BENCHMARK No. 518, ELEVATION = 106.564m, AND BASED ON LOCAL BENCHMARK, CUT CROSS ON SIDEWALK, 1.4m WEST OF SOUTHWEST CORNER OF PROPERTY CORNER ON DIXIE ROAD, ELEVATION = 104.87m, AND AS PROVIDED ON TOPOGRAPHIC SURVEY AUTHORITY.



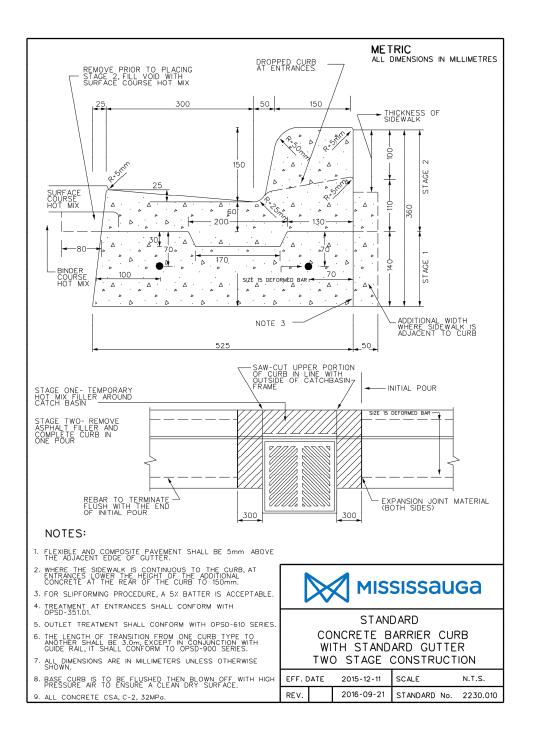

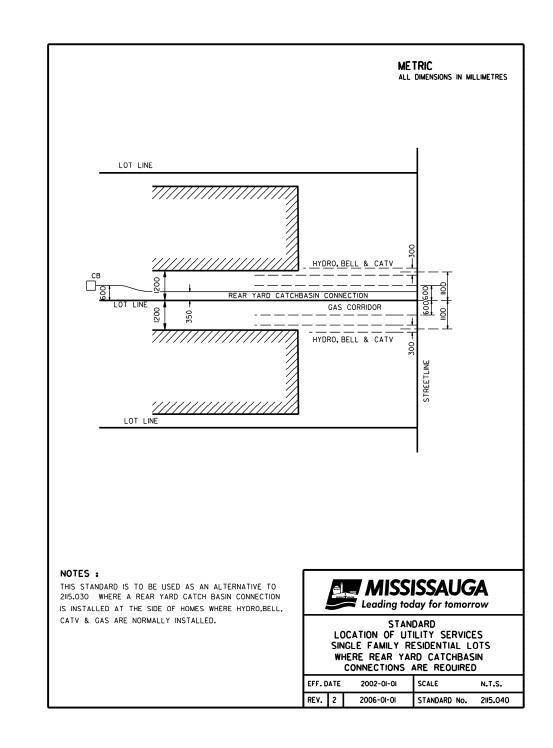

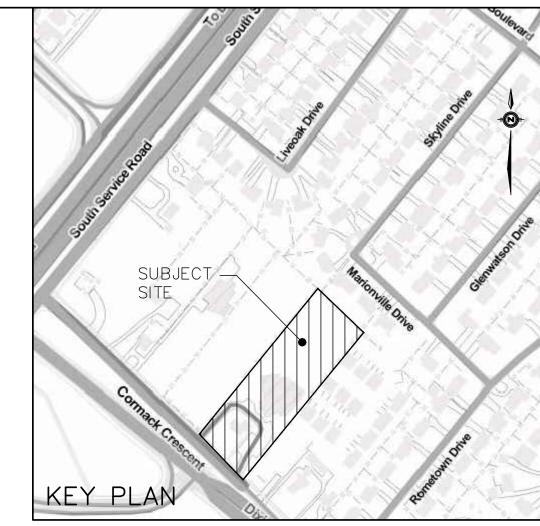





ELM CORMACK (2017) INC.

1931 HIGHWAY 7 CONCORD, ONTARIO L4K 1V5

> tel. 905 709 8232 fax. 905 709 8234

CR MACK MISSISSAUGA, OR 583

SHOWN WILL PRODUCE ADEQUATE SURFACE DRAINAGE AND PROPER FACILITY OF THE MUNICIPAL SERVICES WITHOUT ANY DETRIMENTAL EFFECT TO THE EXISTING DRAINAGE

100130655

ELEVATIONS ARE DERIVED FROM CITY OF MISSISSAUGA BENCHMARK No. 518, ELEVATION = 106.564m, AND

BASED ON LOCAL BENCHMARK, CUT CROSS ON SIDEWALK, 1.4m WEST OF SOUTHWEST CORNER OF

PROPERTY CORNER ON DIXIE ROAD, ELEVATION = 104.87m, AND AS PROVIDED ON TOPOGRAPHIC SURVEY


BY J.D. BARNES LTD. (REF. NO. 18-30-305-00-A),


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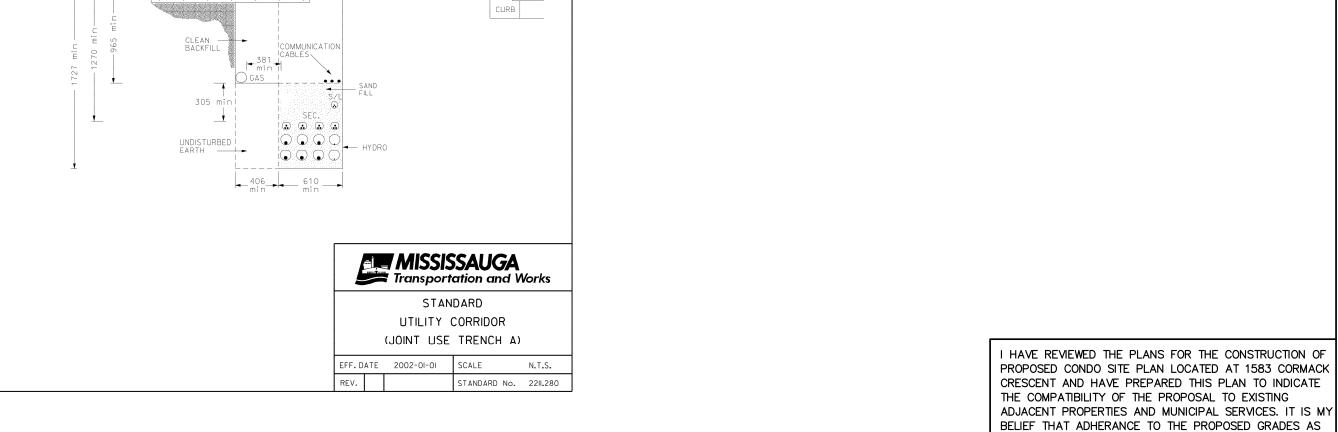
PATTERNS OR ADJACENT PROPERTIES.


PA / PM: H.H.T. / H.T. DRAWN BY: M.M. 4679 JOB NO.:


> SHEET DET-1 **MUNICIPAL DETAILS**




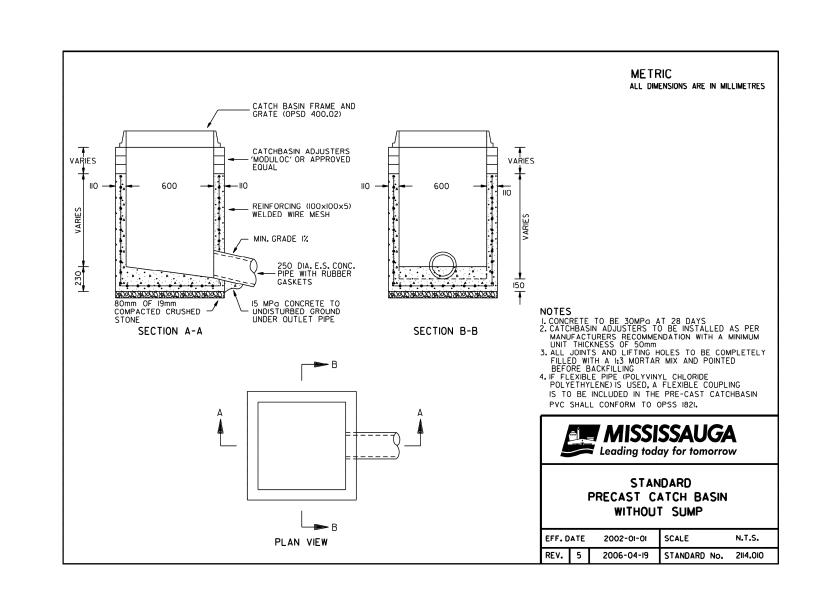


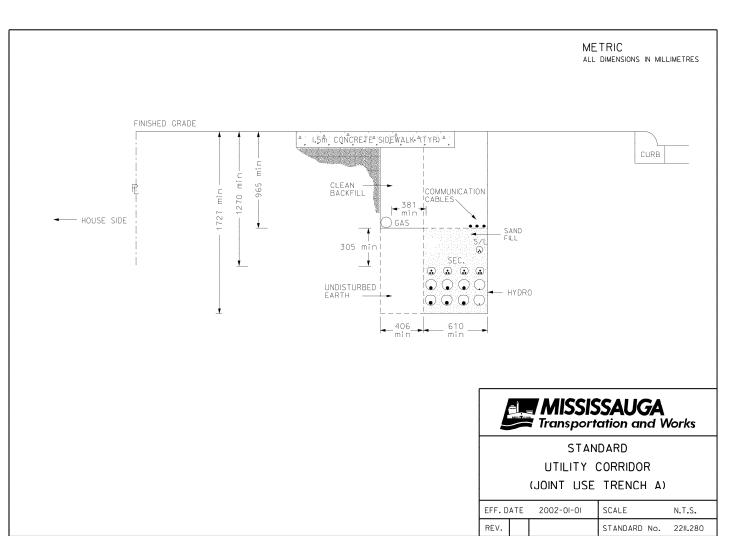


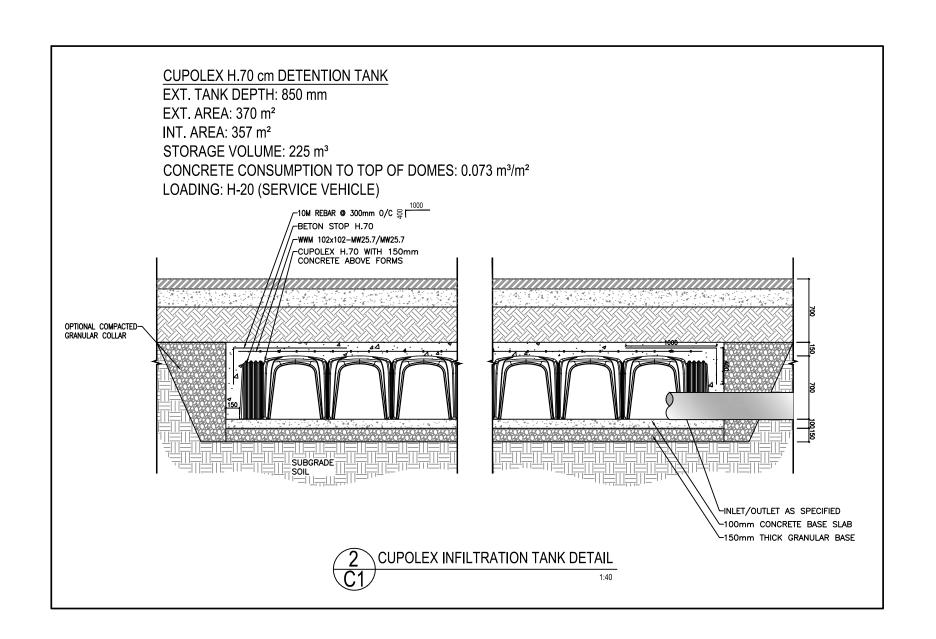


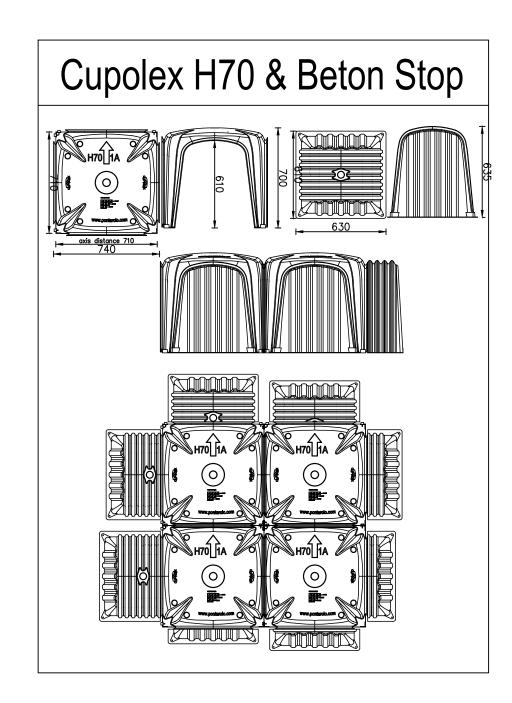


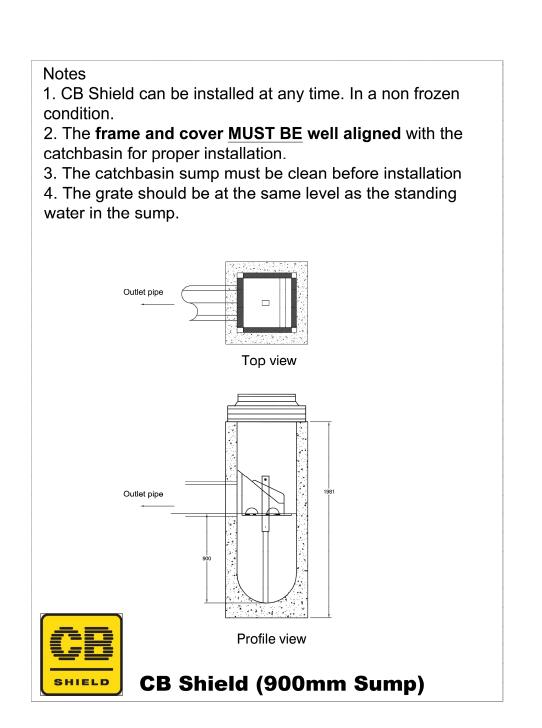

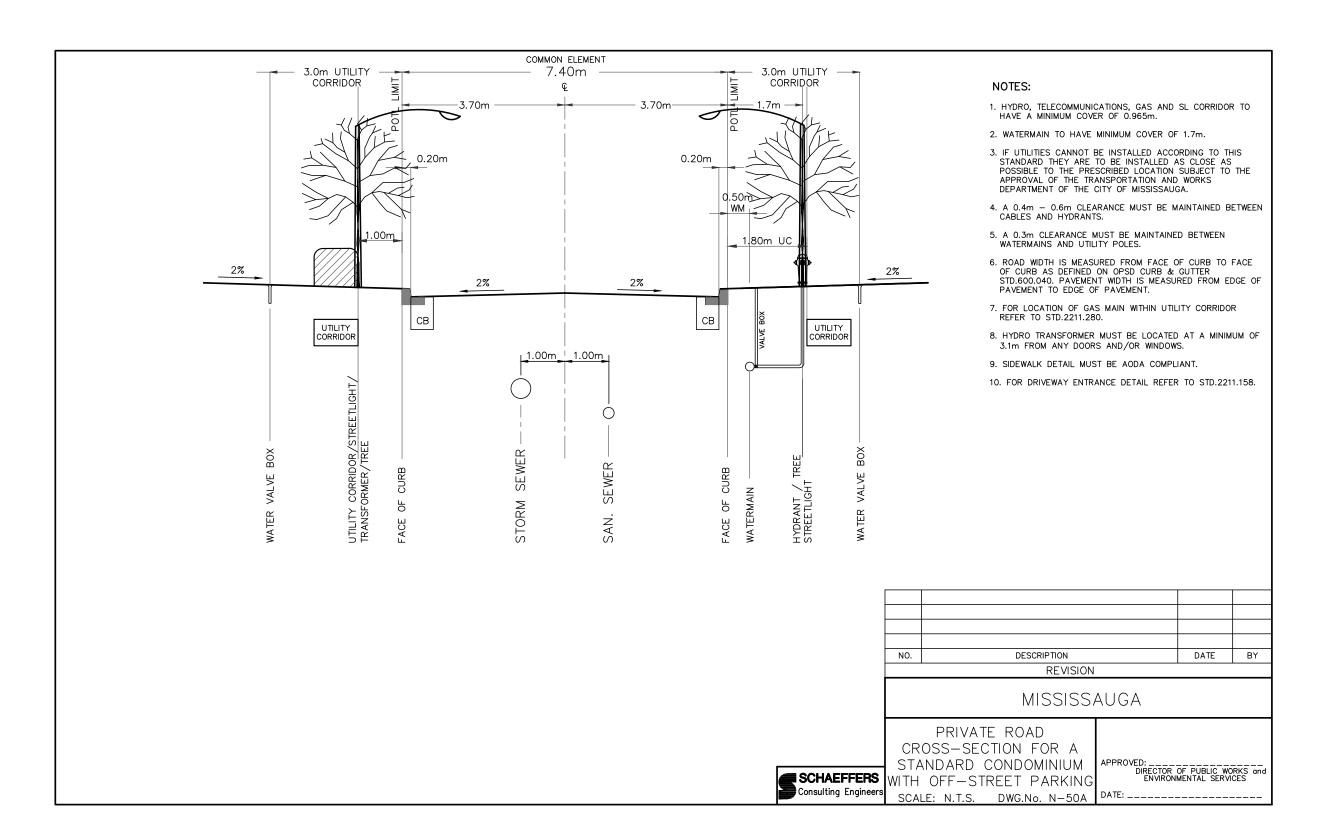

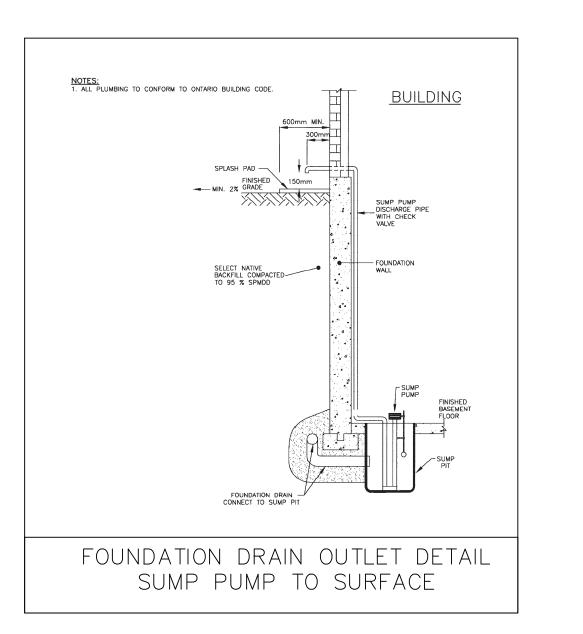

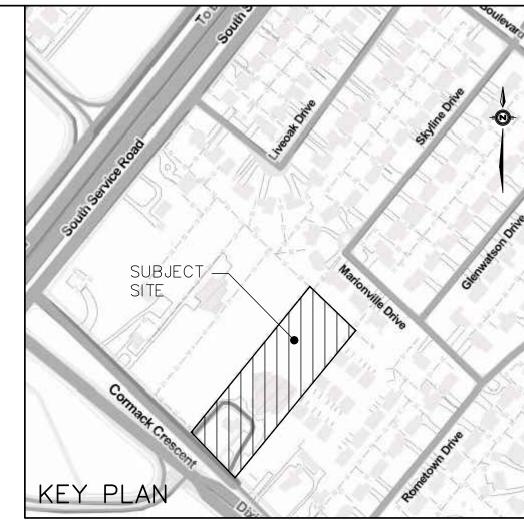

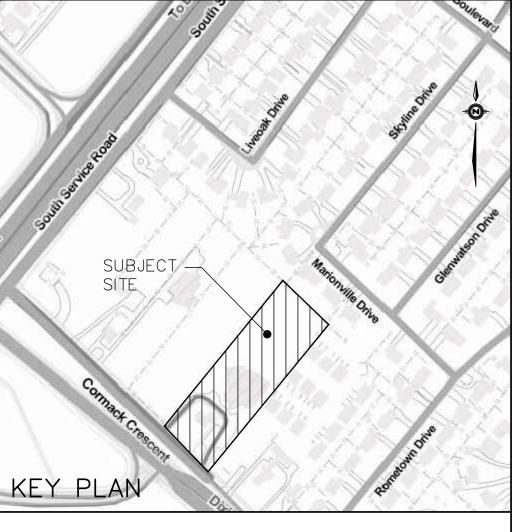




ELM CORMACK (2017) INC.

1931 HIGHWAY 7 CONCORD, ONTARIO L4K 1V5

tel. 905 709 8232 fax. 905 709 8234

CR ORMACK MISSISSAUGA,

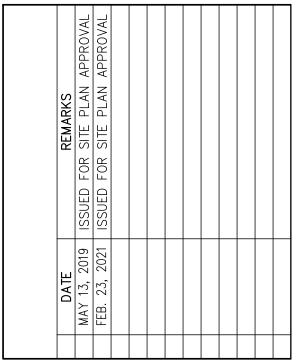


PA / PM:	н.н.т. / н.т.
DRAWN BY:	M.M.
JOB NO.:	4679

ELEVATIONS ARE DERIVED FROM CITY OF MISSISSAUGA BENCHMARK No. 518, ELEVATION = 106.564m, AND BASED ON LOCAL BENCHMARK, CUT CROSS ON SIDEWALK, 1.4m WEST OF SOUTHWEST CORNER OF PROPERTY CORNER ON DIXIE ROAD, ELEVATION = 104.87m, AND AS PROVIDED ON TOPOGRAPHIC SURVEY BY J.D. BARNES LTD. (REF. NO. 18-30-305-00-A), DATED NOVEMBER 29, 2018.

I HAVE REVIEWED THE PLANS FOR THE CONSTRUCTION OF PROPOSED CONDO SITE PLAN LOCATED AT 1583 CORMACK CRESCENT AND HAVE PREPARED THIS PLAN TO INDICATE THE COMPATIBILITY OF THE PROPOSAL TO EXISTING ADJACENT PROPERTIES AND MUNICIPAL SERVICES. IT IS MY BELIEF THAT ADHERANCE TO THE PROPOSED GRADES AS SHOWN WILL PRODUCE ADEQUATE SURFACE DRAINAGE AND PROPER FACILITY OF THE MUNICIPAL SERVICES WITHOUT ANY DETRIMENTAL EFFECT TO THE EXISTING DRAINAGE

PATTERNS OR ADJACENT PROPERTIES.

SHEET DET-2 **PROJECT DETAILS**

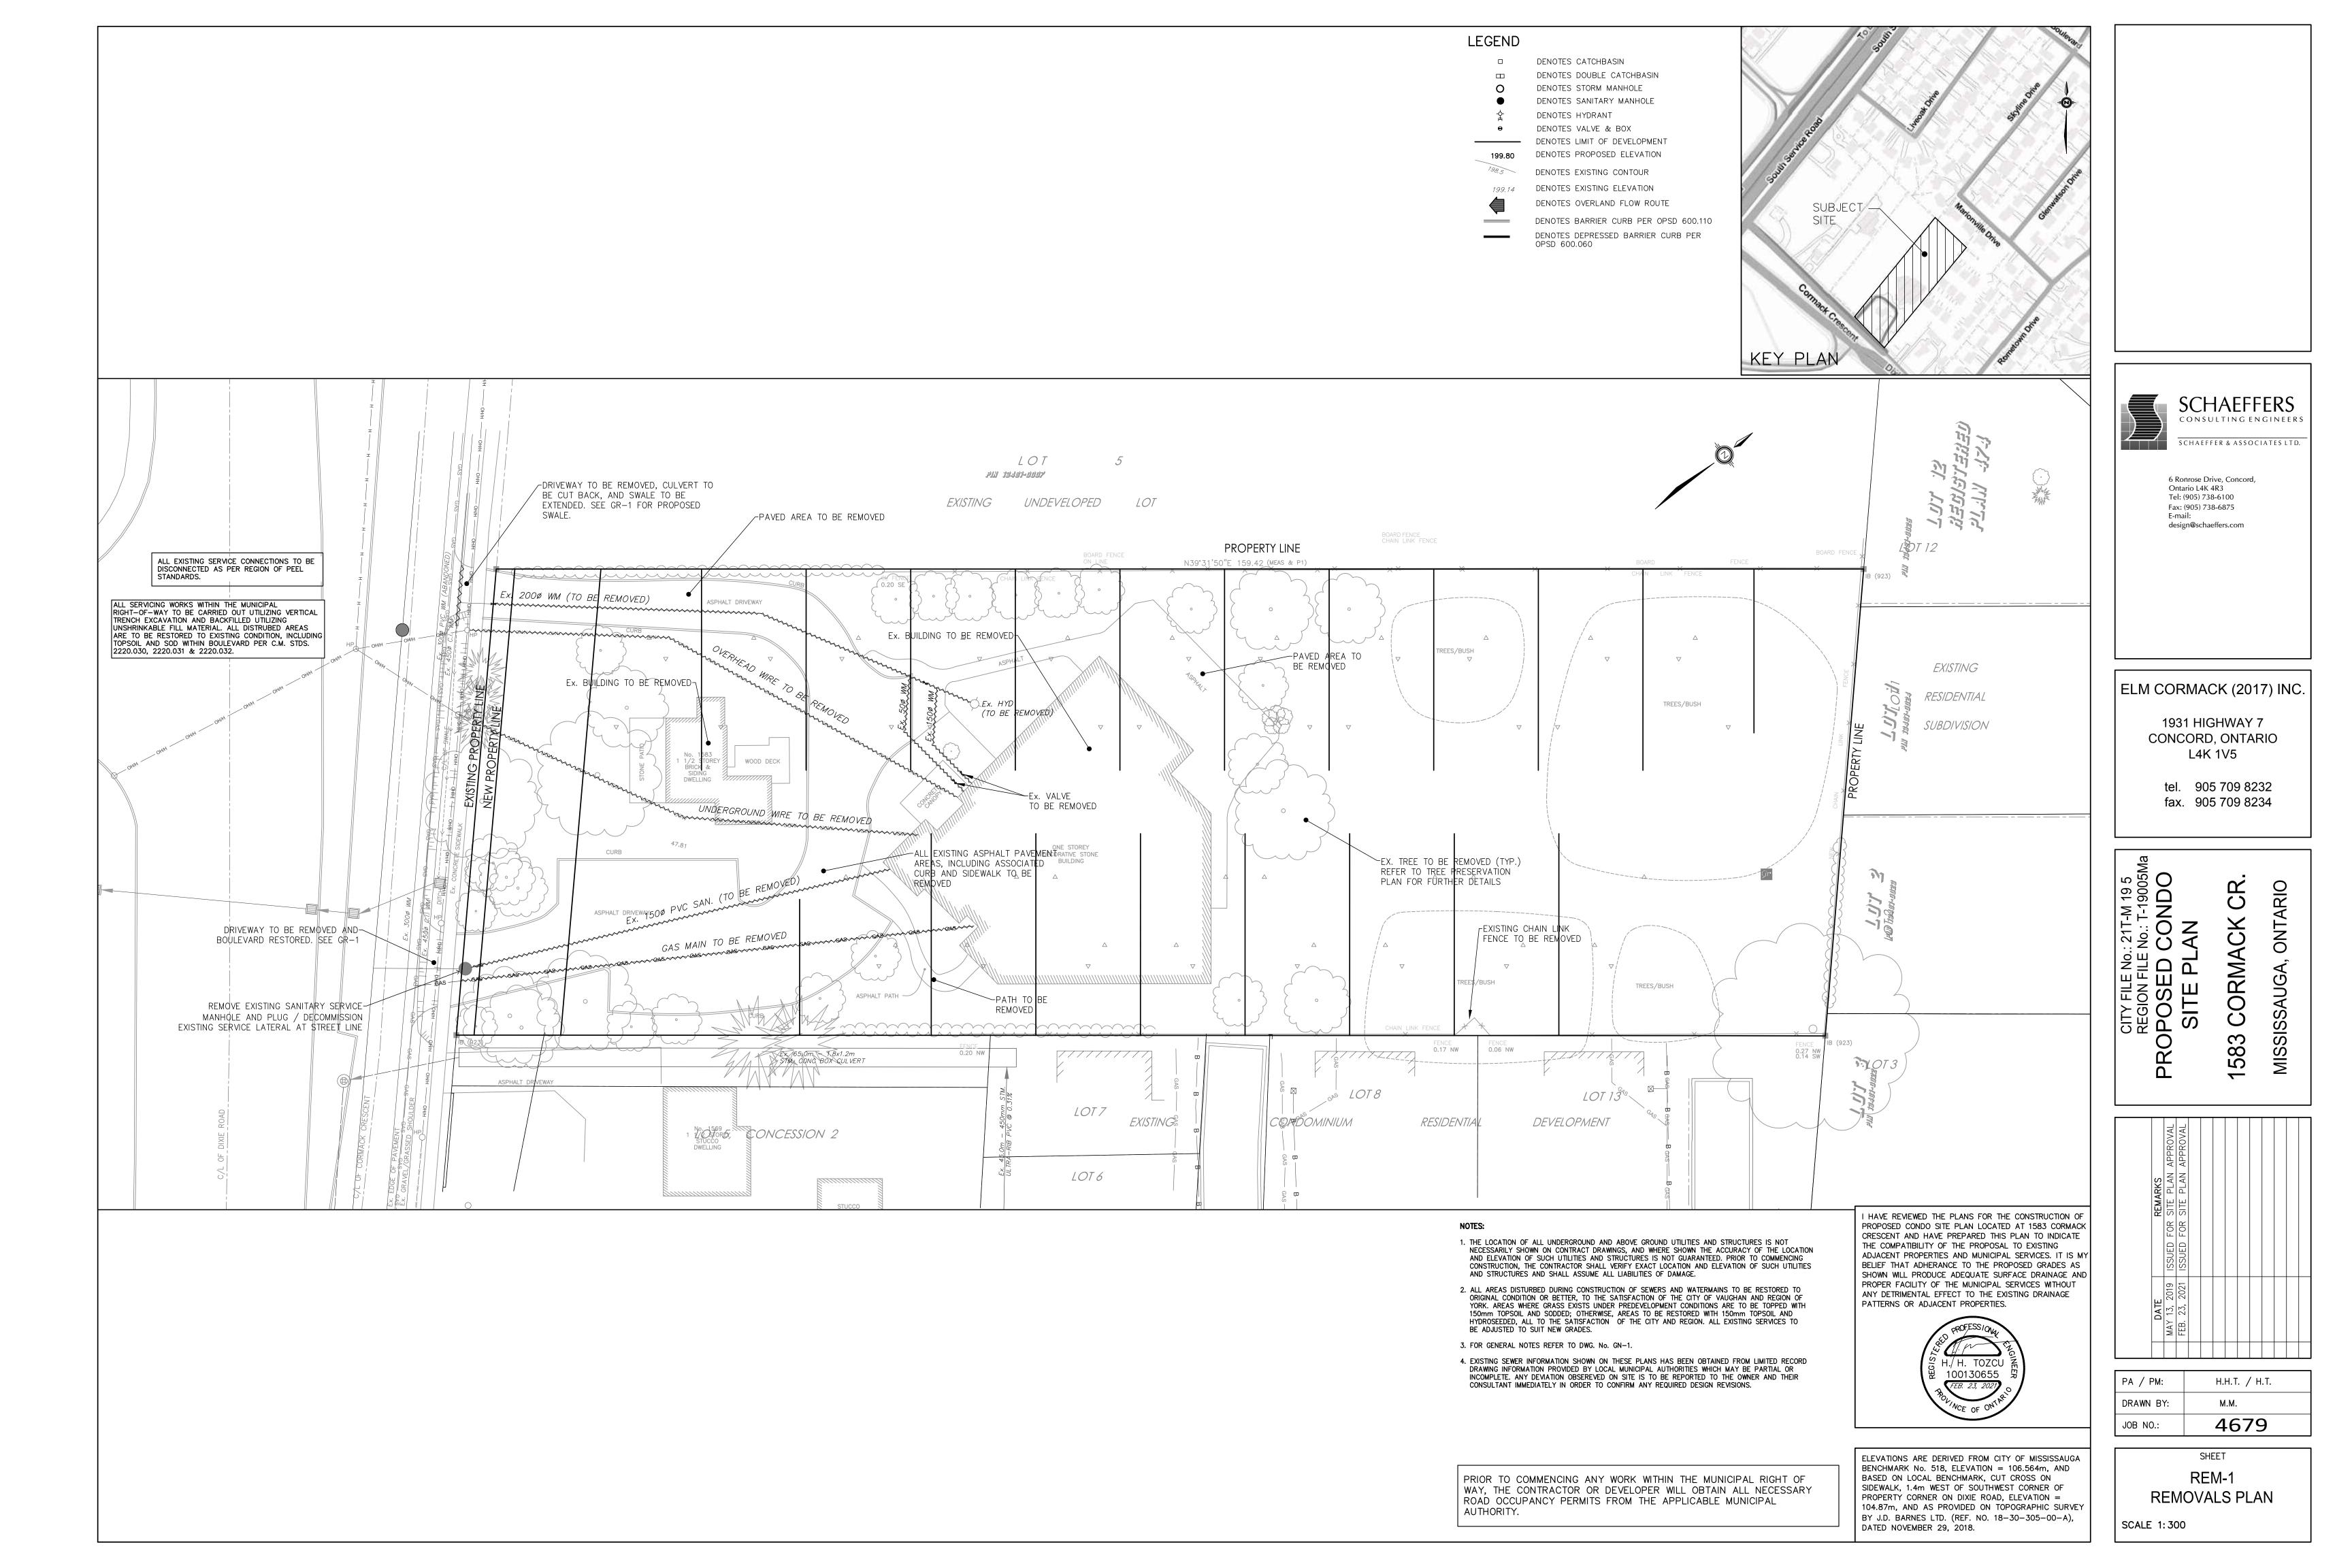

LEGEND

DENOTES TEMPORARY CONSTRUCTION ACCESS

DENOTES SILT FENCE

DENOTES ROCK CHECK DAM



DENOTES TEMP. CUT-OFF SWALE

GENERAL NOTES


- 1. ALL CONCRETE AND PLASTIC SEWER PIPE SHALL HAVE RUBBER GASKET JOINTS. 2. ALL SEWERS SHALL BE CONSTRUCTED WITH BEDDING IN ACCORDANCE WITH
- OPSD 802.03 CLASS "B" UNLESS OTHERWISE NOTED. 3. PLASTIC SEWER PIPES SHALL BE CONSTRUCTED WITH ULTRA RIB OR APPROVED EQUAL UP TO THE MAXIMUM DIAMETER OF 600mm.
- 4. ALL WORKS SHALL BE CONSTRUCTED IN ACCORDANCE WITH CURRENT CITY OF MISSISSAUGA AND OPSD STANDARD DRAWINGS AND SPECIFICATIONS.
- 5. DOUBLE CATCHBASIN LEADS TO BE 250mm UNLESS OTHERWISE NOTED. ALL CATCHBASIN LEADS TO BE EITHER C-14-ES MINIMUM OR P.V.C. TYPE
- 6. ALL BACKFILL FOR SEWERS, WATERMAINS AND UTILITIES ON PAVED AREAS MUST BE MECHANICALLY COMPACTED TO 95% STANDARD PROCTOR DENSITY.


CONDITION OR BETTER TO THE SATISFACTION OF THE CITY OF MISSISSAUGA


- 7. INVERTS, ELEVATIONS AND EXACT LOCATIONS OF ALL EXISTING UNDERGROUND SERVICES TO BE VERIFIED IN THE FIELD BEFORE COMMENCING ANY WORK. 8. ALL AREAS DISTURBED DURING CONSTRUCTION TO BE RESTORED TO ORIGINAL
- AND REGION OF PEEL. 9. GRASSED AREAS TO BE TOPPED WITH 150mm TOPSOIL AND SODDED WITH No.1 NURSERY SOD.
- 10. THE CONTRACTOR SHALL BE RESPONSIBLE FOR CONTROLLING MUD AND DUST ON ALL PUBLIC ROADS TO THE SATISFACTION OF THE CITY AND


SPECIAL NOTE:


- 1. FOR TRAFFIC CONTROL INFORMATION AND MEASURES, REFER TO ONTARIO TRAFFIC MANUAL BOOK 7 (TEMPORARY CONDITIONS)
- 2. THIS CONSTRUCTION MANAGEMENT PLAN CAN BE MODIFIED (AS REQUIRED DURING CONSTRUCTION)
- 3. ANY IMPORTED MATERIAL (IF REQUIRED) WILL BE PLACED AND COMPACTED IMMEDIATELY, NO STOCKPILE IS REQUIRED.
- 4. THIS CONSTRUCTION MANAGEMENT PLAN IS PREPARED FOR SERVICING STAGE. 5. CONTRACTOR TO ENSURED THAT ALL WORKS ARE IN COMPLIANCE WITH THE NOISE BY-LAW.

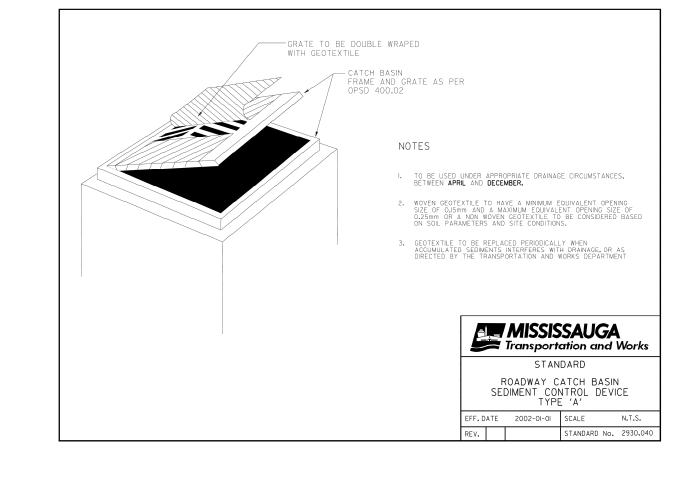


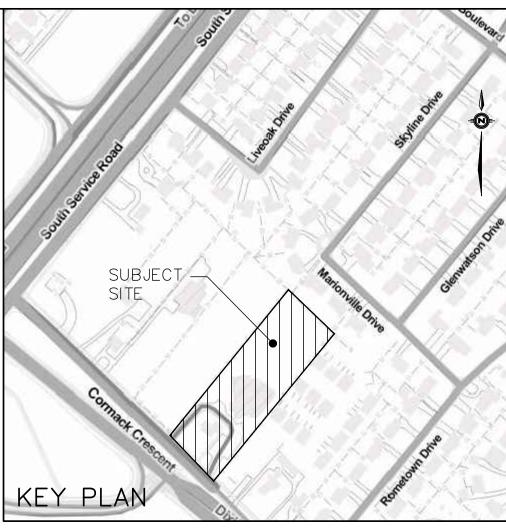


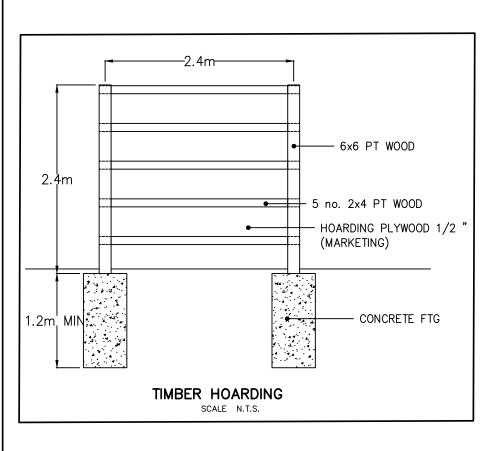


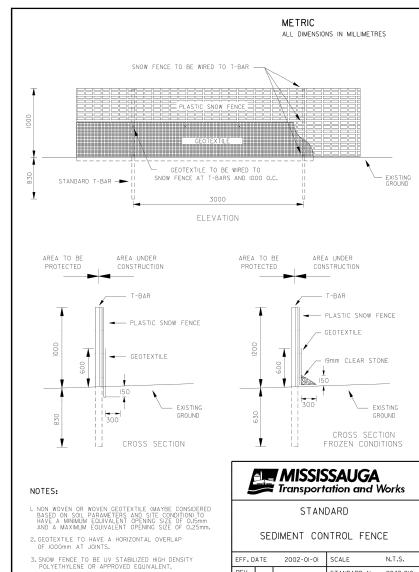

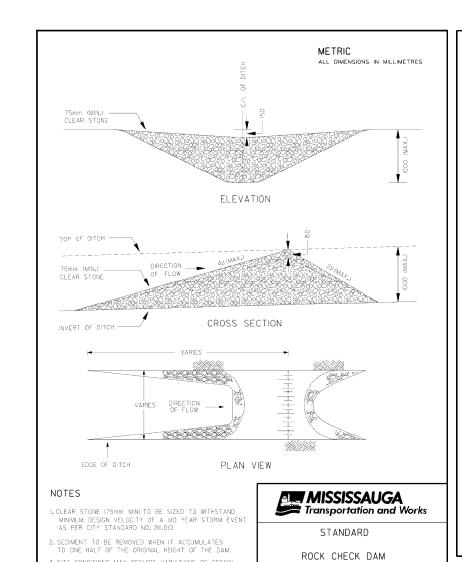

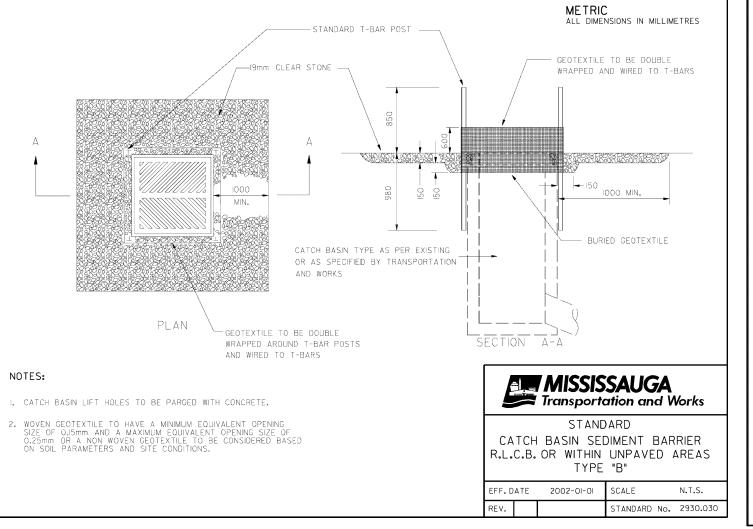


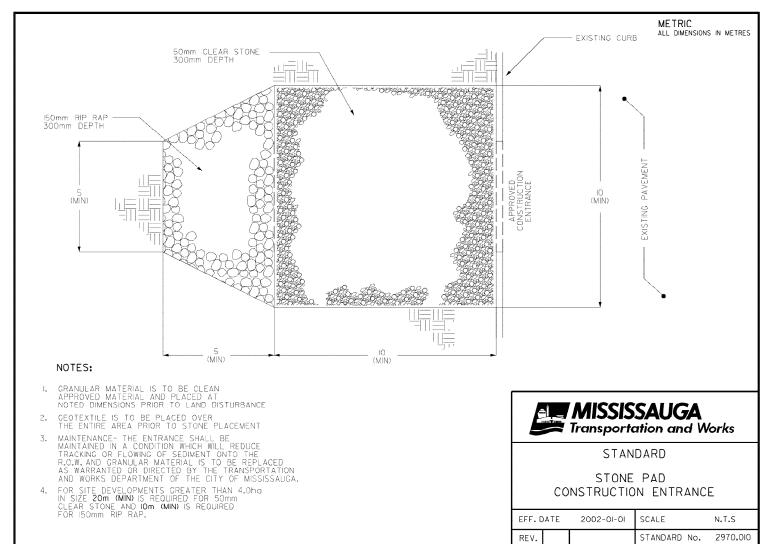

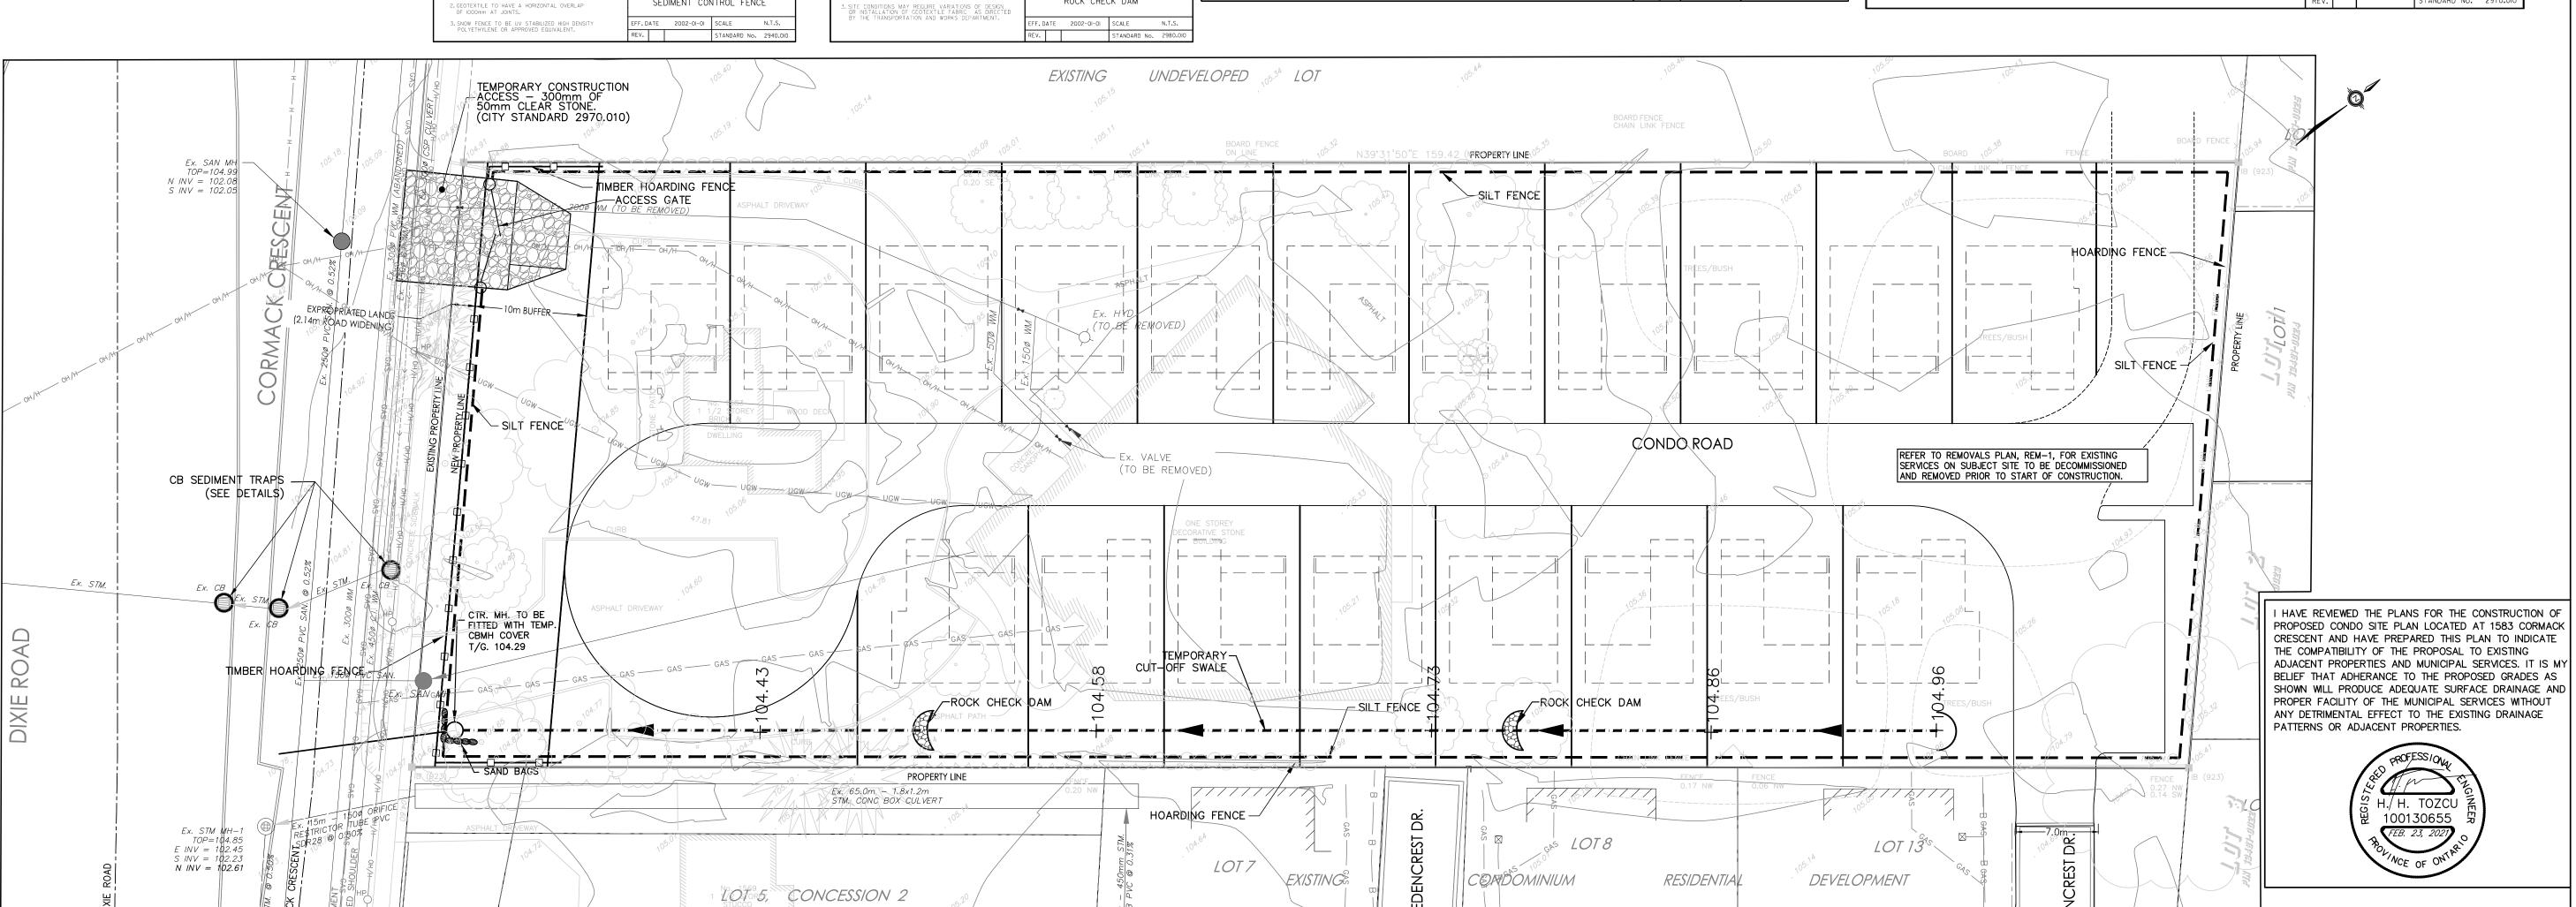

PRIOR TO COMMENCING ANY WORK WITHIN THE MUNICIPAL RIGHT OF WAY, THE CONTRACTOR OR DEVELOPER WILL OBTAIN ALL NECESSARY ROAD OCCUPANCY PERMITS FROM THE APPLICABLE MUNICIPAL AUTHORITY.

ELEVATIONS ARE DERIVED FROM CITY OF MISSISSAUGA BENCHMARK No. 518, ELEVATION = 106.564m, AND BASED ON LOCAL BENCHMARK, CUT CROSS ON SIDEWALK, 1.4m WEST OF SOUTHWEST CORNER OF PROPERTY CORNER ON DIXIE ROAD, ELEVATION = 104.87m, AND AS PROVIDED ON TOPOGRAPHIC SURVEY BY J.D. BARNES LTD. (REF. NO. 18-30-305-00-A), DATED NOVEMBER 29, 2018.

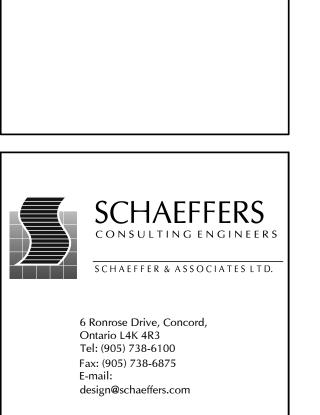

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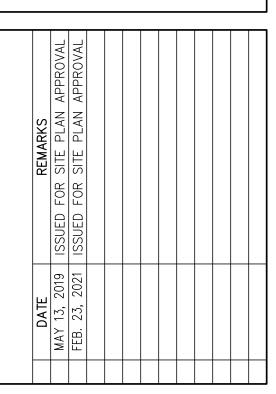
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MISSISSAUGA,

CITY FILE No.: 21T-M 19 5
REGION FILE No.: T-19005M

DPOSED CONDO


SITE PLAN CR ORMACK





H.H.T. / H.T. PA / PM: DRAWN BY: M.M. 4679 JOB NO.:

> SHEET CM-1 CONSTRUCTION MANAGEMENT PLAN

SCALE 1:300

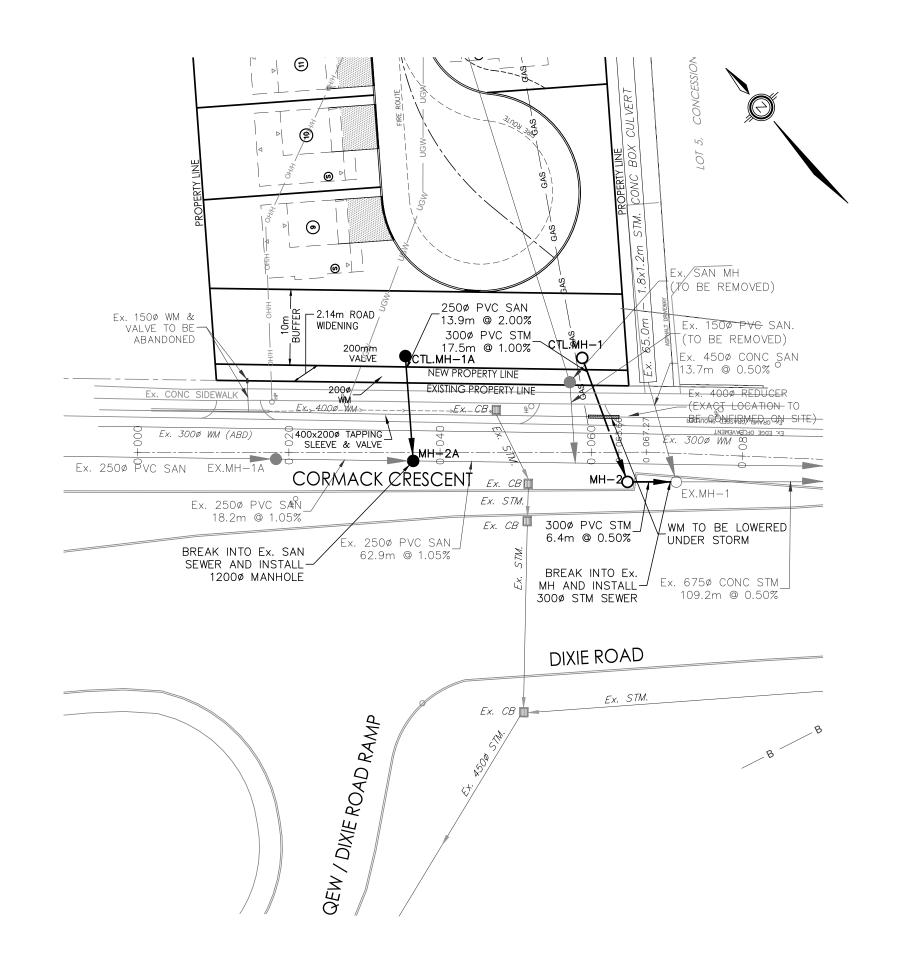

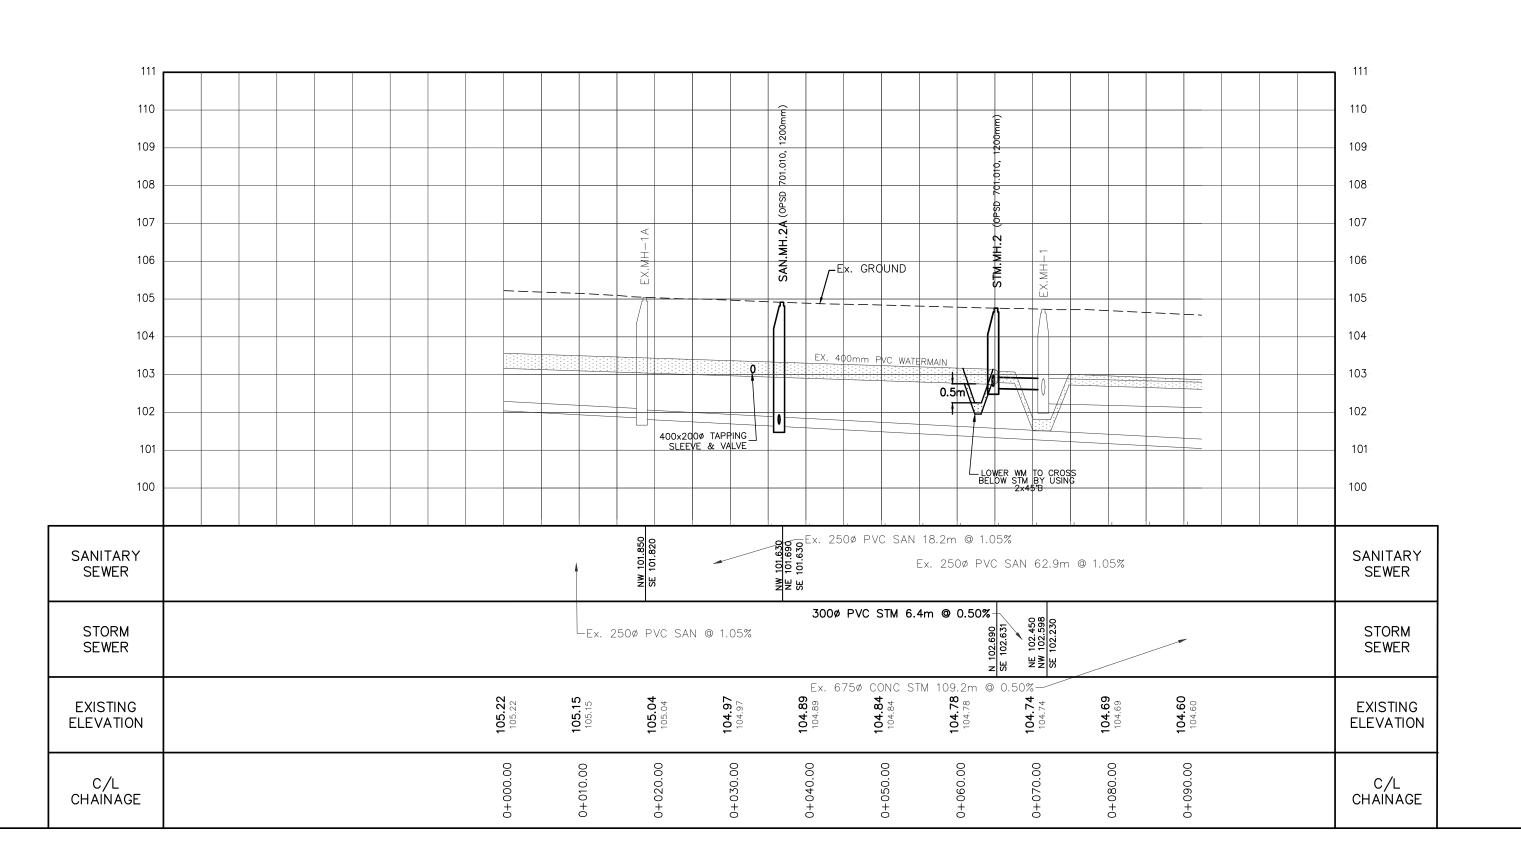

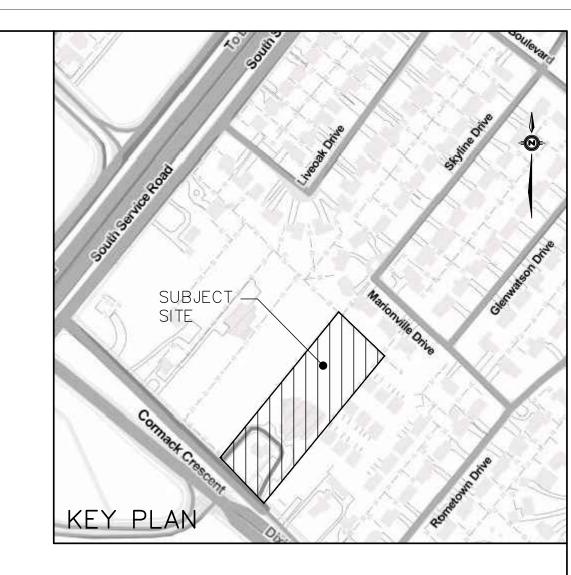

NOTES:

- 1. THE LOCATION OF ALL UNDERGROUND AND ABOVE GROUND UTILITIES AND STRUCTURES IS NOT NECESSARILY SHOWN ON CONTRACT DRAWINGS, AND WHERE SHOWN THE ACCURACY OF THE LOCATION AND ELEVATION OF SUCH UTILITIES AND STRUCTURES IS NOT GUARANTEED. PRIOR TO COMMENCING CONSTRUCTION, THE CONTRACTOR SHALL VERIFY EXACT LOCATION AND ELEVATION OF SUCH UTILITIES AND STRUCTURES AND SHALL ASSUME ALL LIABILITIES OF DAMAGE.
- 2. ALL AREAS DISTURBED DURING CONSTRUCTION OF SEWERS AND WATERMAINS TO BE RESTORED TO ORIGINAL CONDITION OR BETTER, TO THE SATISFACTION OF THE CITY OF VAUGHAN AND REGION OF YORK. AREAS WHERE GRASS EXISTS UNDER PREDEVELOPMENT CONDITIONS ARE TO BE TOPPED WITH 150mm TOPSOIL AND SODDED; OTHERWISE, AREAS TO BE RESTORED WITH 150mm TOPSOIL AND HYDROSEEDED, ALL TO THE SATISFACTION OF THE CITY AND REGION. ALL EXISTING SERVICES TO BE ADJUSTED TO SUIT NEW GRADES.

3. FOR GENERAL NOTES REFER TO DWG. No. GN-1.

4. EXISTING SEWER INFORMATION SHOWN ON THESE PLANS HAS BEEN OBTAINED FROM LIMITED RECORD DRAWING INFORMATION PROVIDED BY LOCAL MUNICIPAL AUTHORITIES WHICH MAY BE PARTIAL OR INCOMPLETE. ANY DEVIATION OBSEREVED ON SITE IS TO BE REPORTED TO THE OWNER AND THEIR CONSULTANT IMMEDIATELY IN ORDER TO CONFIRM ANY REQUIRED DESIGN REVISIONS.

> I HAVE REVIEWED THE PLANS FOR THE CONSTRUCTION OF PROPOSED CONDO SITE PLAN LOCATED AT 1583 CORMACK


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> SHOWN WILL PRODUCE ADEQUATE SURFACE DRAINAGE AND PROPER FACILITY OF THE MUNICIPAL SERVICES WITHOUT ANY DETRIMENTAL EFFECT TO THE EXISTING DRAINAGE

ELEVATIONS ARE BASED ON ONTARIO BASE MAPPING

OBTAINED FROM FIRST BASE SOLUTIONS.

PATTERNS OR ADJACENT PROPERTIES.



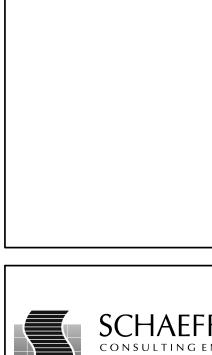

6 Ronrose Drive, Concord, Ontario L4K 4R3 Tel: (905) 738-6100 Fax: (905) 738-6875 E-mail:



ELM DEVELOPMENTS

1931 HIGHWAY 7 CONCORD, ONTARIO L4K 1V5


tel. 905 709 8232 fax. 905 709 8234

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CORMACK

ONTARIO

MISSISSAUGA,

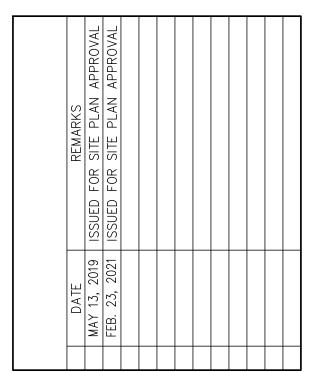

PA / PM:	н.н.т. / н.т.
DRAWN BY:	M.M.
JOB NO.:	4679

SHEET PP-1 PLAN AND PROFILE

CORMACK CRESCENT

SCALE 1:500H 1:100V