# STREETSCAPING FEASIBILITY STUDY

## 579, 619 LAKESHORE ROAD EAST AND 1022, 1028 CAVEN STREET CITY OF MISSISSAUGA REGION OF PEEL

PREPARED FOR: STAR SEEKER INC.

PREPARED BY:

C.F. CROZIER & ASSOCIATES INC. 2800 HIGH POINT DRIVE, SUITE 100 MILTON, ON L9T 6P4

OCTOBER 2022

CFCA FILE NO. 1876-5866

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Revision Number	Date	Comments
Rev.A	December, 2021	Issued for Coordination
Rev.0	October, 2022	Issued for Submission

C.F. Crozier & Associates Inc.

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SFS-P: STREETSCAPE AND UTILITY PLAN

SFS-S: STREETSCAPE SECTIONS LAKESHORE ROAD EAST

#### 1.0 Introduction

C.F. Crozier & Associates Inc. (Crozier) was retained by Star Seeker Inc. to prepare a Streetscaping Feasibility Study. This study will support the applications for a Zoning By-Law Amendment (ZBA) required to permit the mixed-use development of 579, 619 Lakeshore Road East and 1022, 1028 Caven Street in the City of Mississauga, Region of Peel (hereby known as the 'proposed development').

The proposed development is in an Amended Boulevard Treatment Area. The Streetscaping Feasibility Study has been completed for the proposed development as required by the City of Mississauga and is in accordance with the Streetscape Feasibility Terms of Reference, dated May 2, 2019. The purpose of the study is to demonstrate that the proposed development can accommodate the appropriate boulevard treatment within the public right-of-way and that the associated building setbacks are adequate.

The complete study consists of two parts:

- 1. Streetscape and Utility Plan
- 2. Streetscape Sections Plan

Enclosed Drawings SFS-P and SFS-S reflect the Streetscape Utility Plan and Streetscape Sections Plan respectively. These plans are based on the subsurface utility investigation completed by R&B Locating in July 2021.

## 2.0 Streetscape and Utility Plan

The Streetscape Plan is based on the existing utility locations present along Lakeshore Road East. Information regarding existing underground utilities is based on the topographic survey by R-PE Surveying Ltd. (March 2, 2021) and a Subsurface Utility Engineering (SUE) on-site locates investigation prepared by R&B Locating (July 2021).

Two cross-sections, as shown on Drawing SFS-S, have been taken along Lakeshore Road East. All sections have been prepared in accordance with City policies as required in the Streetscape Feasibility Study Terms of Reference (May 2, 2019)

#### 3.0 Streetscape Sections Plan

Drawing SFS-P reflects the Streetscape Corridor Location along the north boulevard of Lakeshore Road East right-of-way (R.O.W.). Per the City's requirements, a streetscape corridor with minimum plan area of 2.0 m x 2.0 m is proposed at a minimum distance of 0.75 m from the back of the municipal curb. The streetscape corridor will be designed with an amended treatment (concrete paving) to accommodate the minimum 2.0 m width. Landscape drawings prepared by Strybos Barron King Ltd. (SBK), dated October 18, 2022 (attached) present the design. The proposed sidewalk width has been set at 2.1 m, or greater, and accommodates a 2.5 m wide streetscape corridor within the existing boulevard width. The existing R.O.W. limits are illustrated on the cross-sections shown on Drawing SFS-S.

According to the utility locates survey, and as shown on Drawing SFS-P, there is an existing Gas Service, Fiber Optic Cables, Traffic Light Cables, Storm Sewer, Sanitary Sewers, Watermains, and Utility Pole/Streetlights which cross the streetscape corridor of the proposed development. None of these services present conflicts with the proposed streetscaping layout. However, two (2) Utility Poles/Streetlights are conflicting with the proposed lay-by parking. As such, the conflicts are to be resolved in the future by relocating either the lay-by parking or Utility Poles. Refer to Drawing SFS-P for details.

The building setbacks are labelled on Drawing SFS-S. It is required to have a minimum building setback of 2.8 m from the tree trench. The buildings fronting Lakeshore Road East have a setback of approximately 6 m from the tree trench alignment. Therefore, the buildings are adequately set back from tree trench. The Landscape Architect (SBK) is responsible to identify trees that adhere to the above-grade street tree canopy clearances as shown in the drawings of the Streetscaping Feasibility Terms of Reference.

#### 4.0 Conclusions

Based on the details contained in this Streetscaping Feasibility Study, an appropriate boulevard treatment can be accommodated within the public right-of-way adjacent to Lakeshore Road East, in accordance with the City of Mississauga's Streetscape Feasibility Terms of Reference. Modifications to the boulevard treatment are not required to prevent conflicts with existing utilities.

Respectfully submitted,

C.F. CROZIER & ASSOCIATES INC.

C.F. CROZIER & ASSOCIATES INC.


Jayesh Boily, E.I.T. Land Development Matt Britton, P.Eng.

Project Manager – Land Development

JB/cj


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# **DRAWINGS**

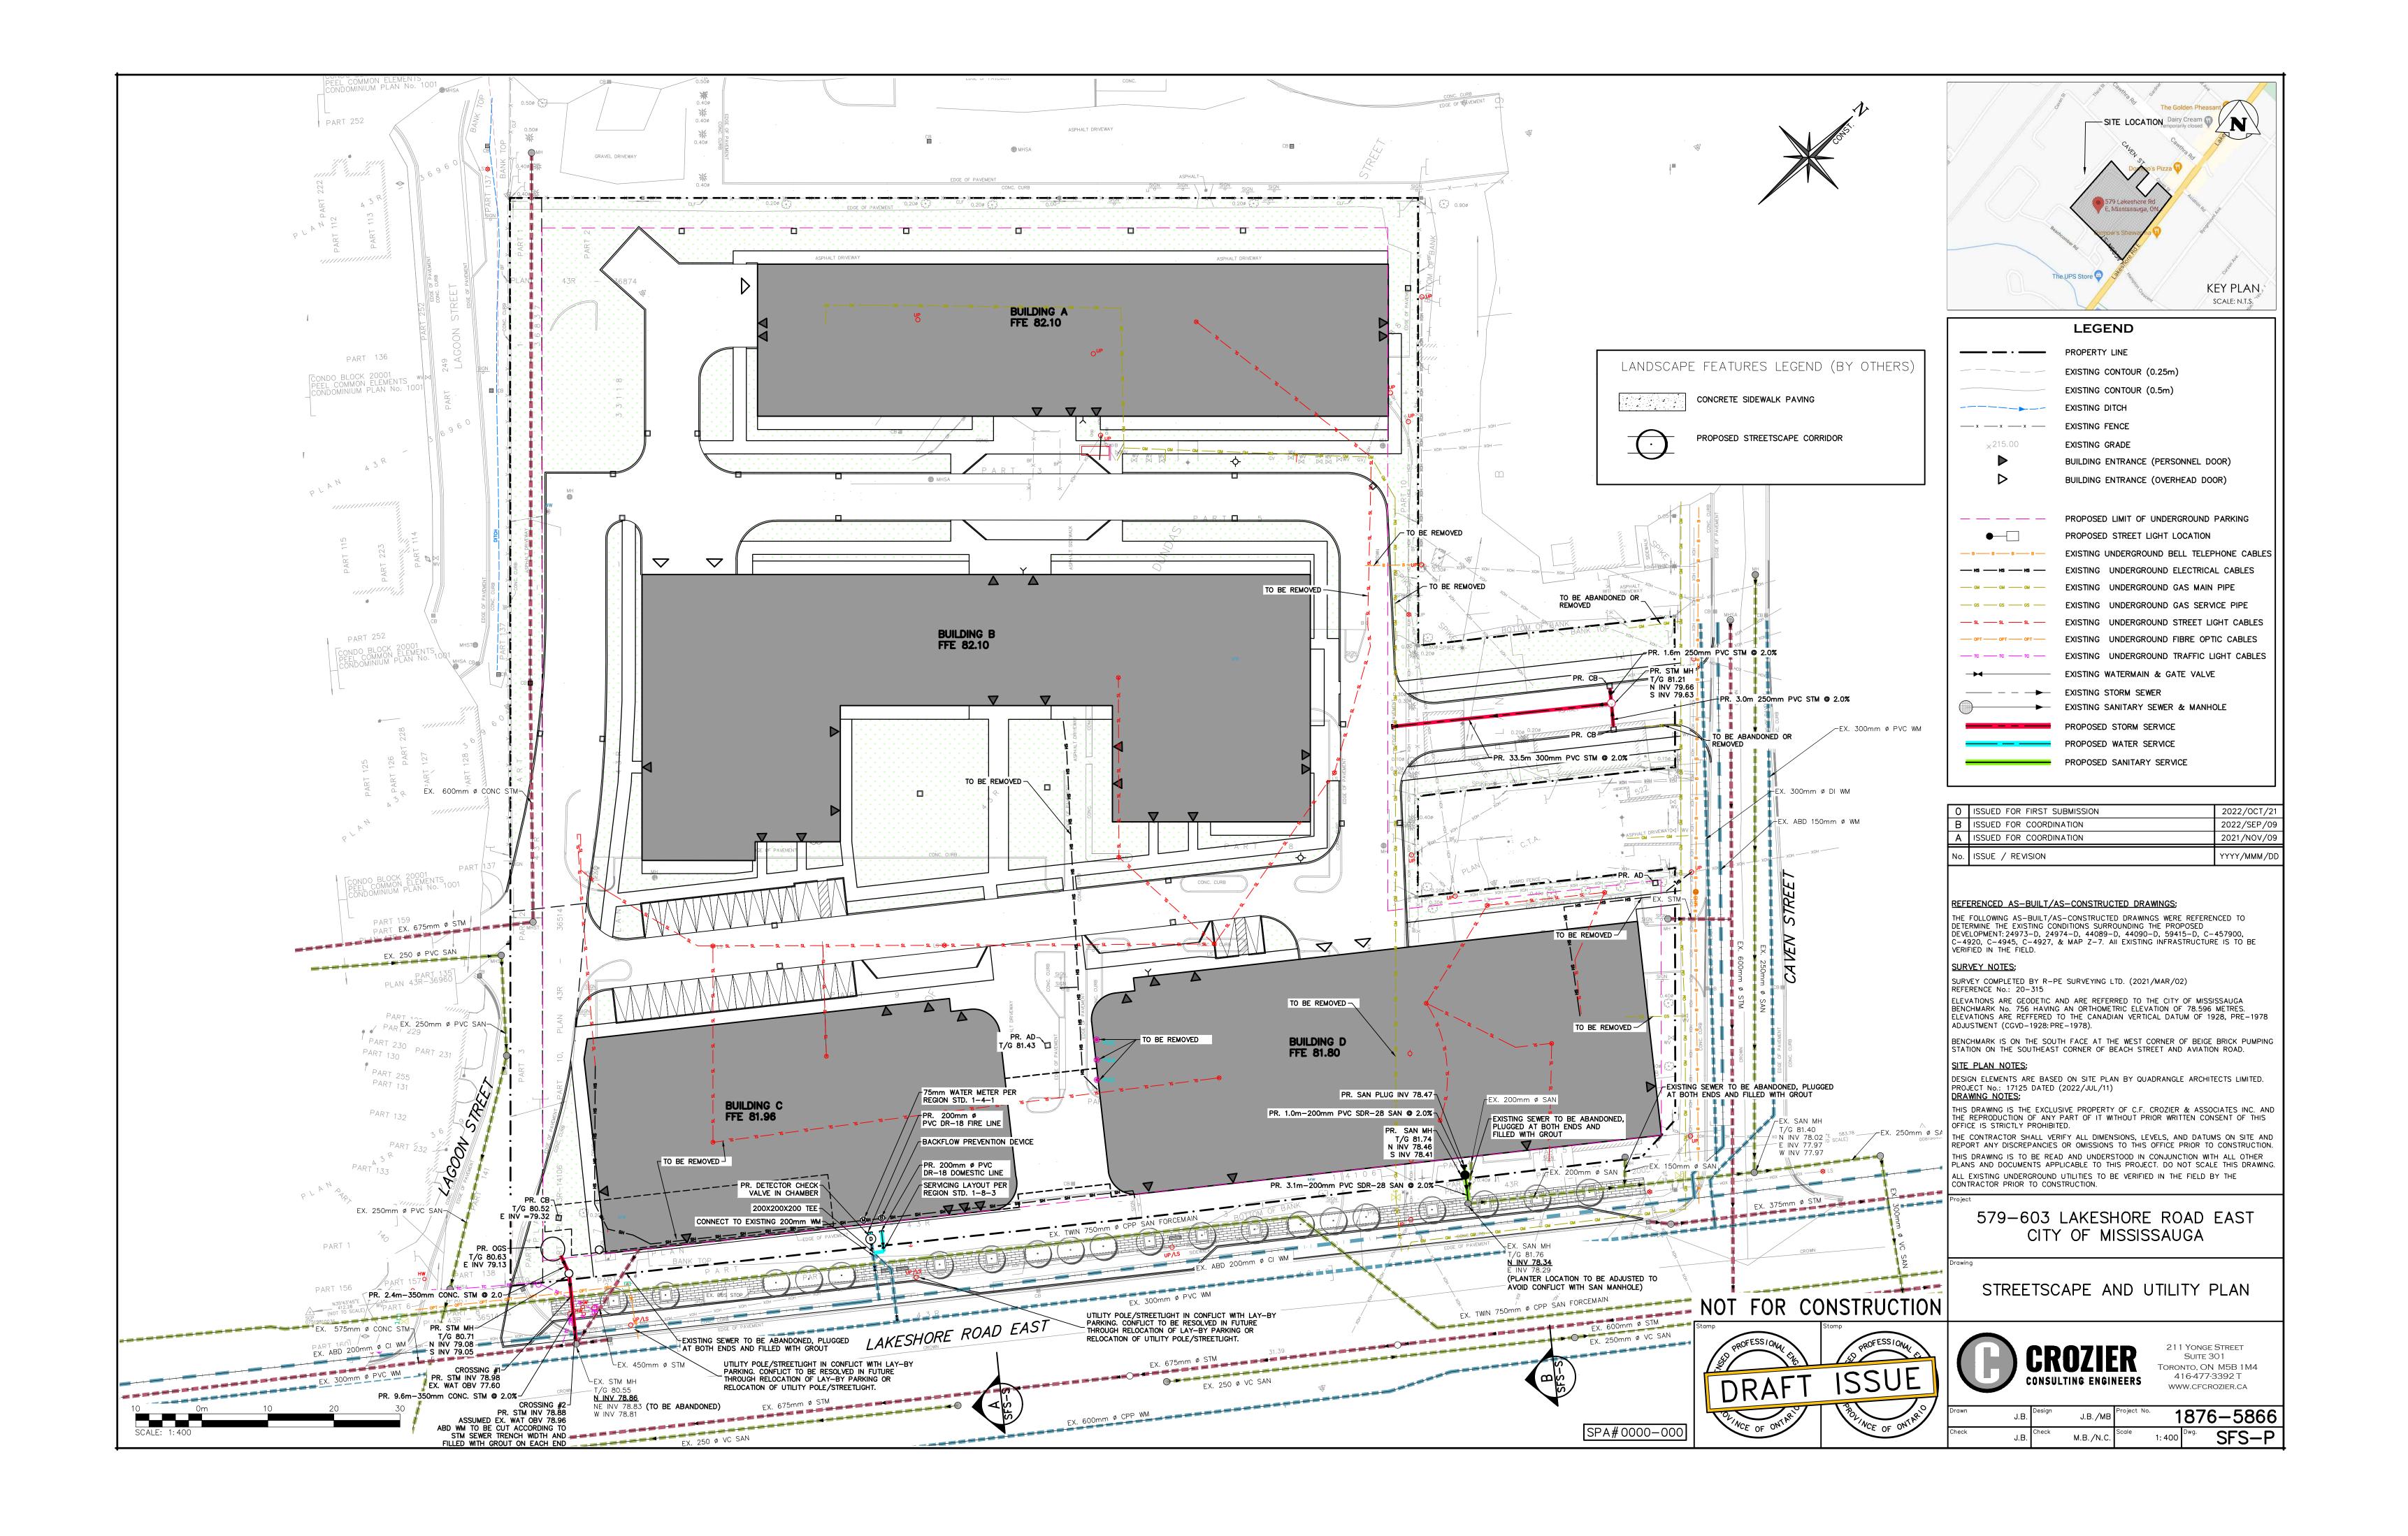



# SECTION A

SCALE: H: 1:100 V: 1:50

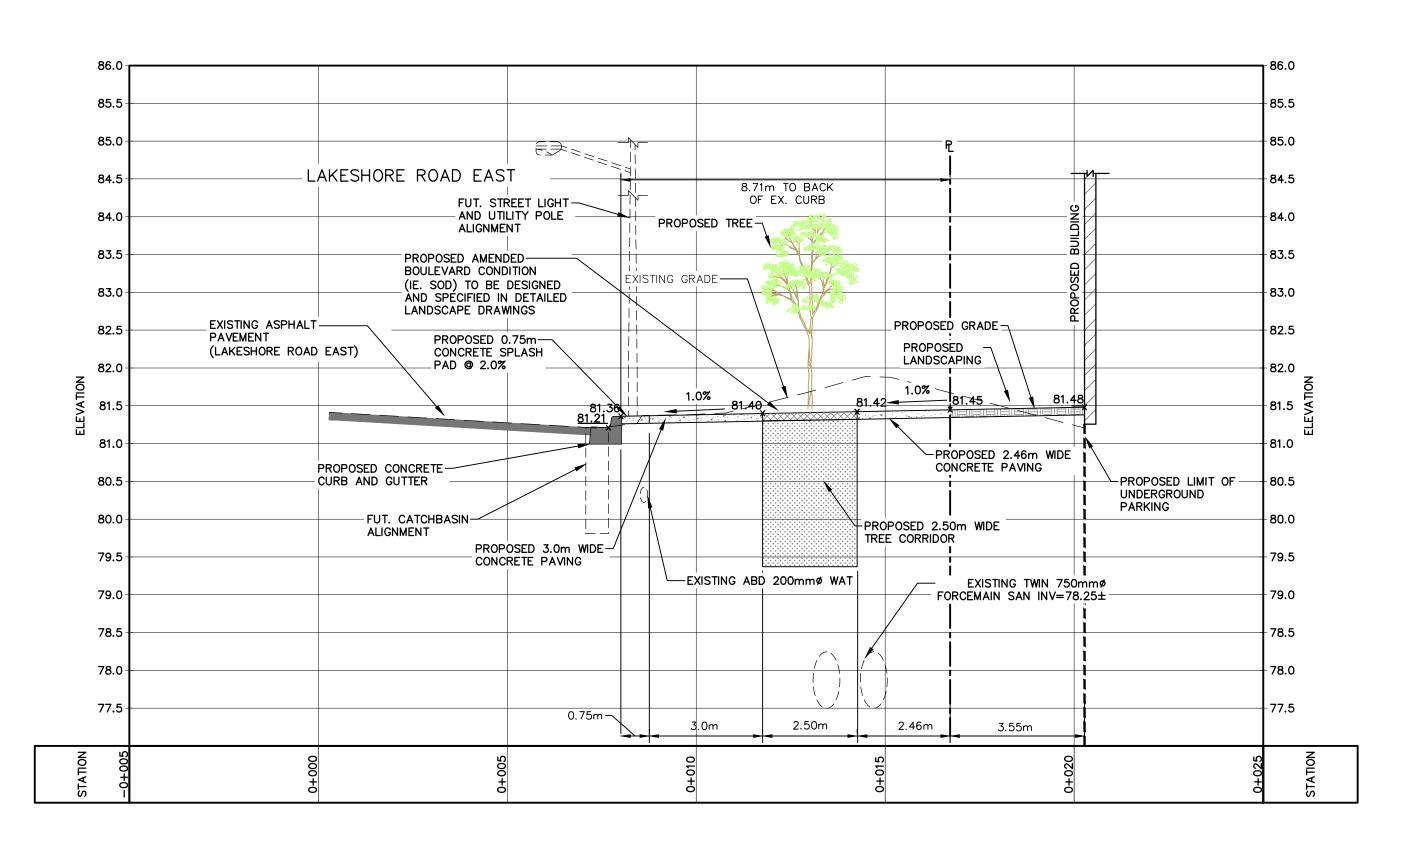

SECTION B SCALE: H: 1:100 V: 1:50

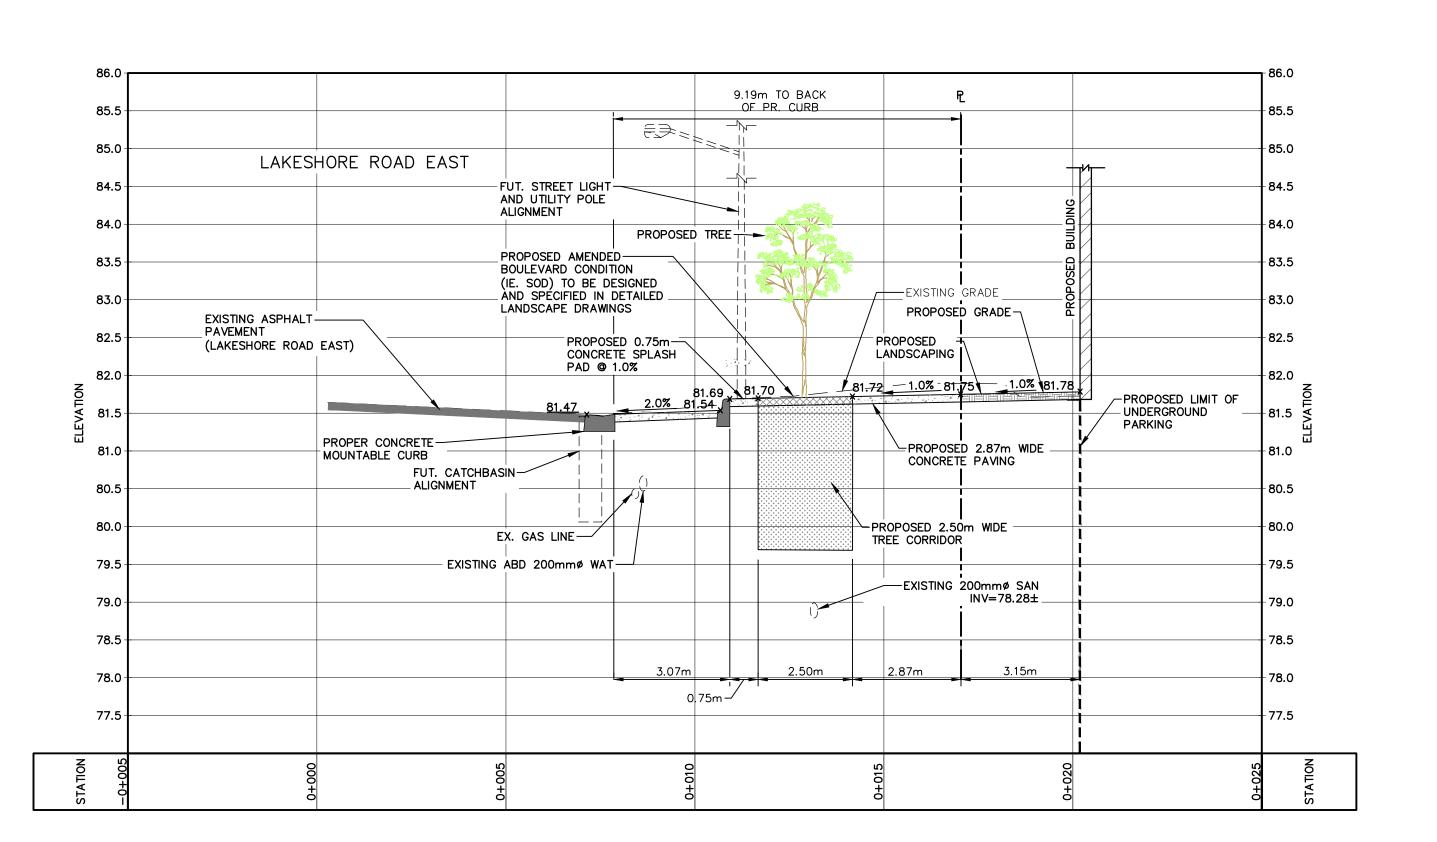

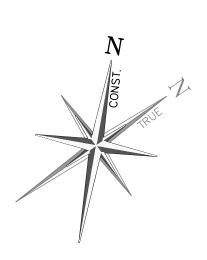



## NOTES

- 1. SEE LANDSCAPE DESIGN DRAWINGS, DETAILS AND SPECIFICATIONS FOR STREETSCAPE INSTALLATION. (ie. TREES, SIDEWALK ETC.)
- 2. CANOPY CLEARANCES SHOULD CONFORM WITH MISSISSAUGA STREETSCAPE FEASIBILITY TERMS OF REFERENCE, FIGURE 1.
- 3. ALL TREES TO BE PLANTED IN SOD.
- 4. CONTRACTOR TO VERIFY THE EXACT VERTICAL ELEVATION OF EXISTING GAS, BELL AND ROGERS UTILITY LINES.

FOR LOCATION OF THE SECTIONS SHOWN ON THIS DRAWING SEE DRAWING SFS-P

0	ISSUED FOR FIRST SUBMISSION	2022/OCT/21
Ф	ISSUED FOR COORDINATION	2022/SEP/09
Α	ISSUED FOR COORDINATION	2021/NOV/09
No.	ISSUE / REVISION	YYYY/MMM/DD

## REFERENCED AS-BUILT/AS-CONSTRUCTED DRAWINGS:

THE FOLLOWING AS-BUILT/AS-CONSTRUCTED DRAWINGS WERE REFERENCED TO DETERMINE THE EXISTING CONDITIONS SURROUNDING THE PROPOSED DEVELOPMENT: 24973-D, 24974-D, 44089-D, 44090-D, 59415-D, C-457900, C-4920, C-4945, C-4927, & MAP Z-7. All EXISTING INFRASTRUCTURE IS TO BE VERIFIED IN THE FIELD.

## SURVEY NOTES:

SURVEY COMPLETED BY R-PE SURVEYING LTD. (2021/MAR/02) REFERENCE No.: 20-315

ELEVATIONS ARE GEODETIC AND ARE REFERRED TO THE CITY OF MISSISSAUGA BENCHMARK No. 756 HAVING AN ORTHOMETRIC ELEVATION OF 78.596 METRES. ELEVATIONS ARE REFFERED TO THE CANADIAN VERTICAL DATUM OF 1928, PRE-1978 ADJUSTMENT (CGVD-1928: PRE-1978).

BENCHMARK IS ON THE SOUTH FACE AT THE WEST CORNER OF BEIGE BRICK PUMPING STATION ON THE SOUTHEAST CORNER OF BEACH STREET AND AVIATION ROAD.

DESIGN ELEMENTS ARE BASED ON SITE PLAN BY QUADRANGLE ARCHITECTS LIMITED. PROJECT No.: 17125 DATED (2022/JUL/11)

DRAWING NOTES:

THIS DRAWING IS THE EXCLUSIVE PROPERTY OF C.F. CROZIER & ASSOCIATES INC. AND THE REPRODUCTION OF ANY PART OF IT WITHOUT PRIOR WRITTEN CONSENT OF THIS OFFICE IS STRICTLY PROHIBITED.


THE CONTRACTOR SHALL VERIFY ALL DIMENSIONS, LEVELS, AND DATUMS ON SITE AND REPORT ANY DISCREPANCIES OR OMISSIONS TO THIS OFFICE PRIOR TO CONSTRUCTION.

THIS DRAWING IS TO BE READ AND UNDERSTOOD IN CONJUNCTION WITH ALL OTHER PLANS AND DOCUMENTS APPLICABLE TO THIS PROJECT. DO NOT SCALE THIS DRAWING. ALL EXISTING UNDERGROUND UTILITIES TO BE VERIFIED IN THE FIELD BY THE CONTRACTOR PRIOR TO CONSTRUCTION.

579-603 LAKESHORE ROAD EAST CITY OF MISSISSAUGA

STREETSCAPE SECTIONS LAKESHORE ROAD EAST

NOT FOR CONSTRUCTION

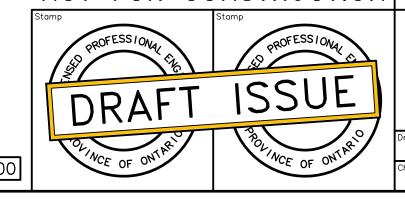




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J.B. Design J.B./MB Project No. 1876-5866

Deck J.B. Check M.B./N.C. Scale AS SHOWN Dwg. SFS—S

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# SUPPORTING DOCUMENTATION



GENERAL NOTES

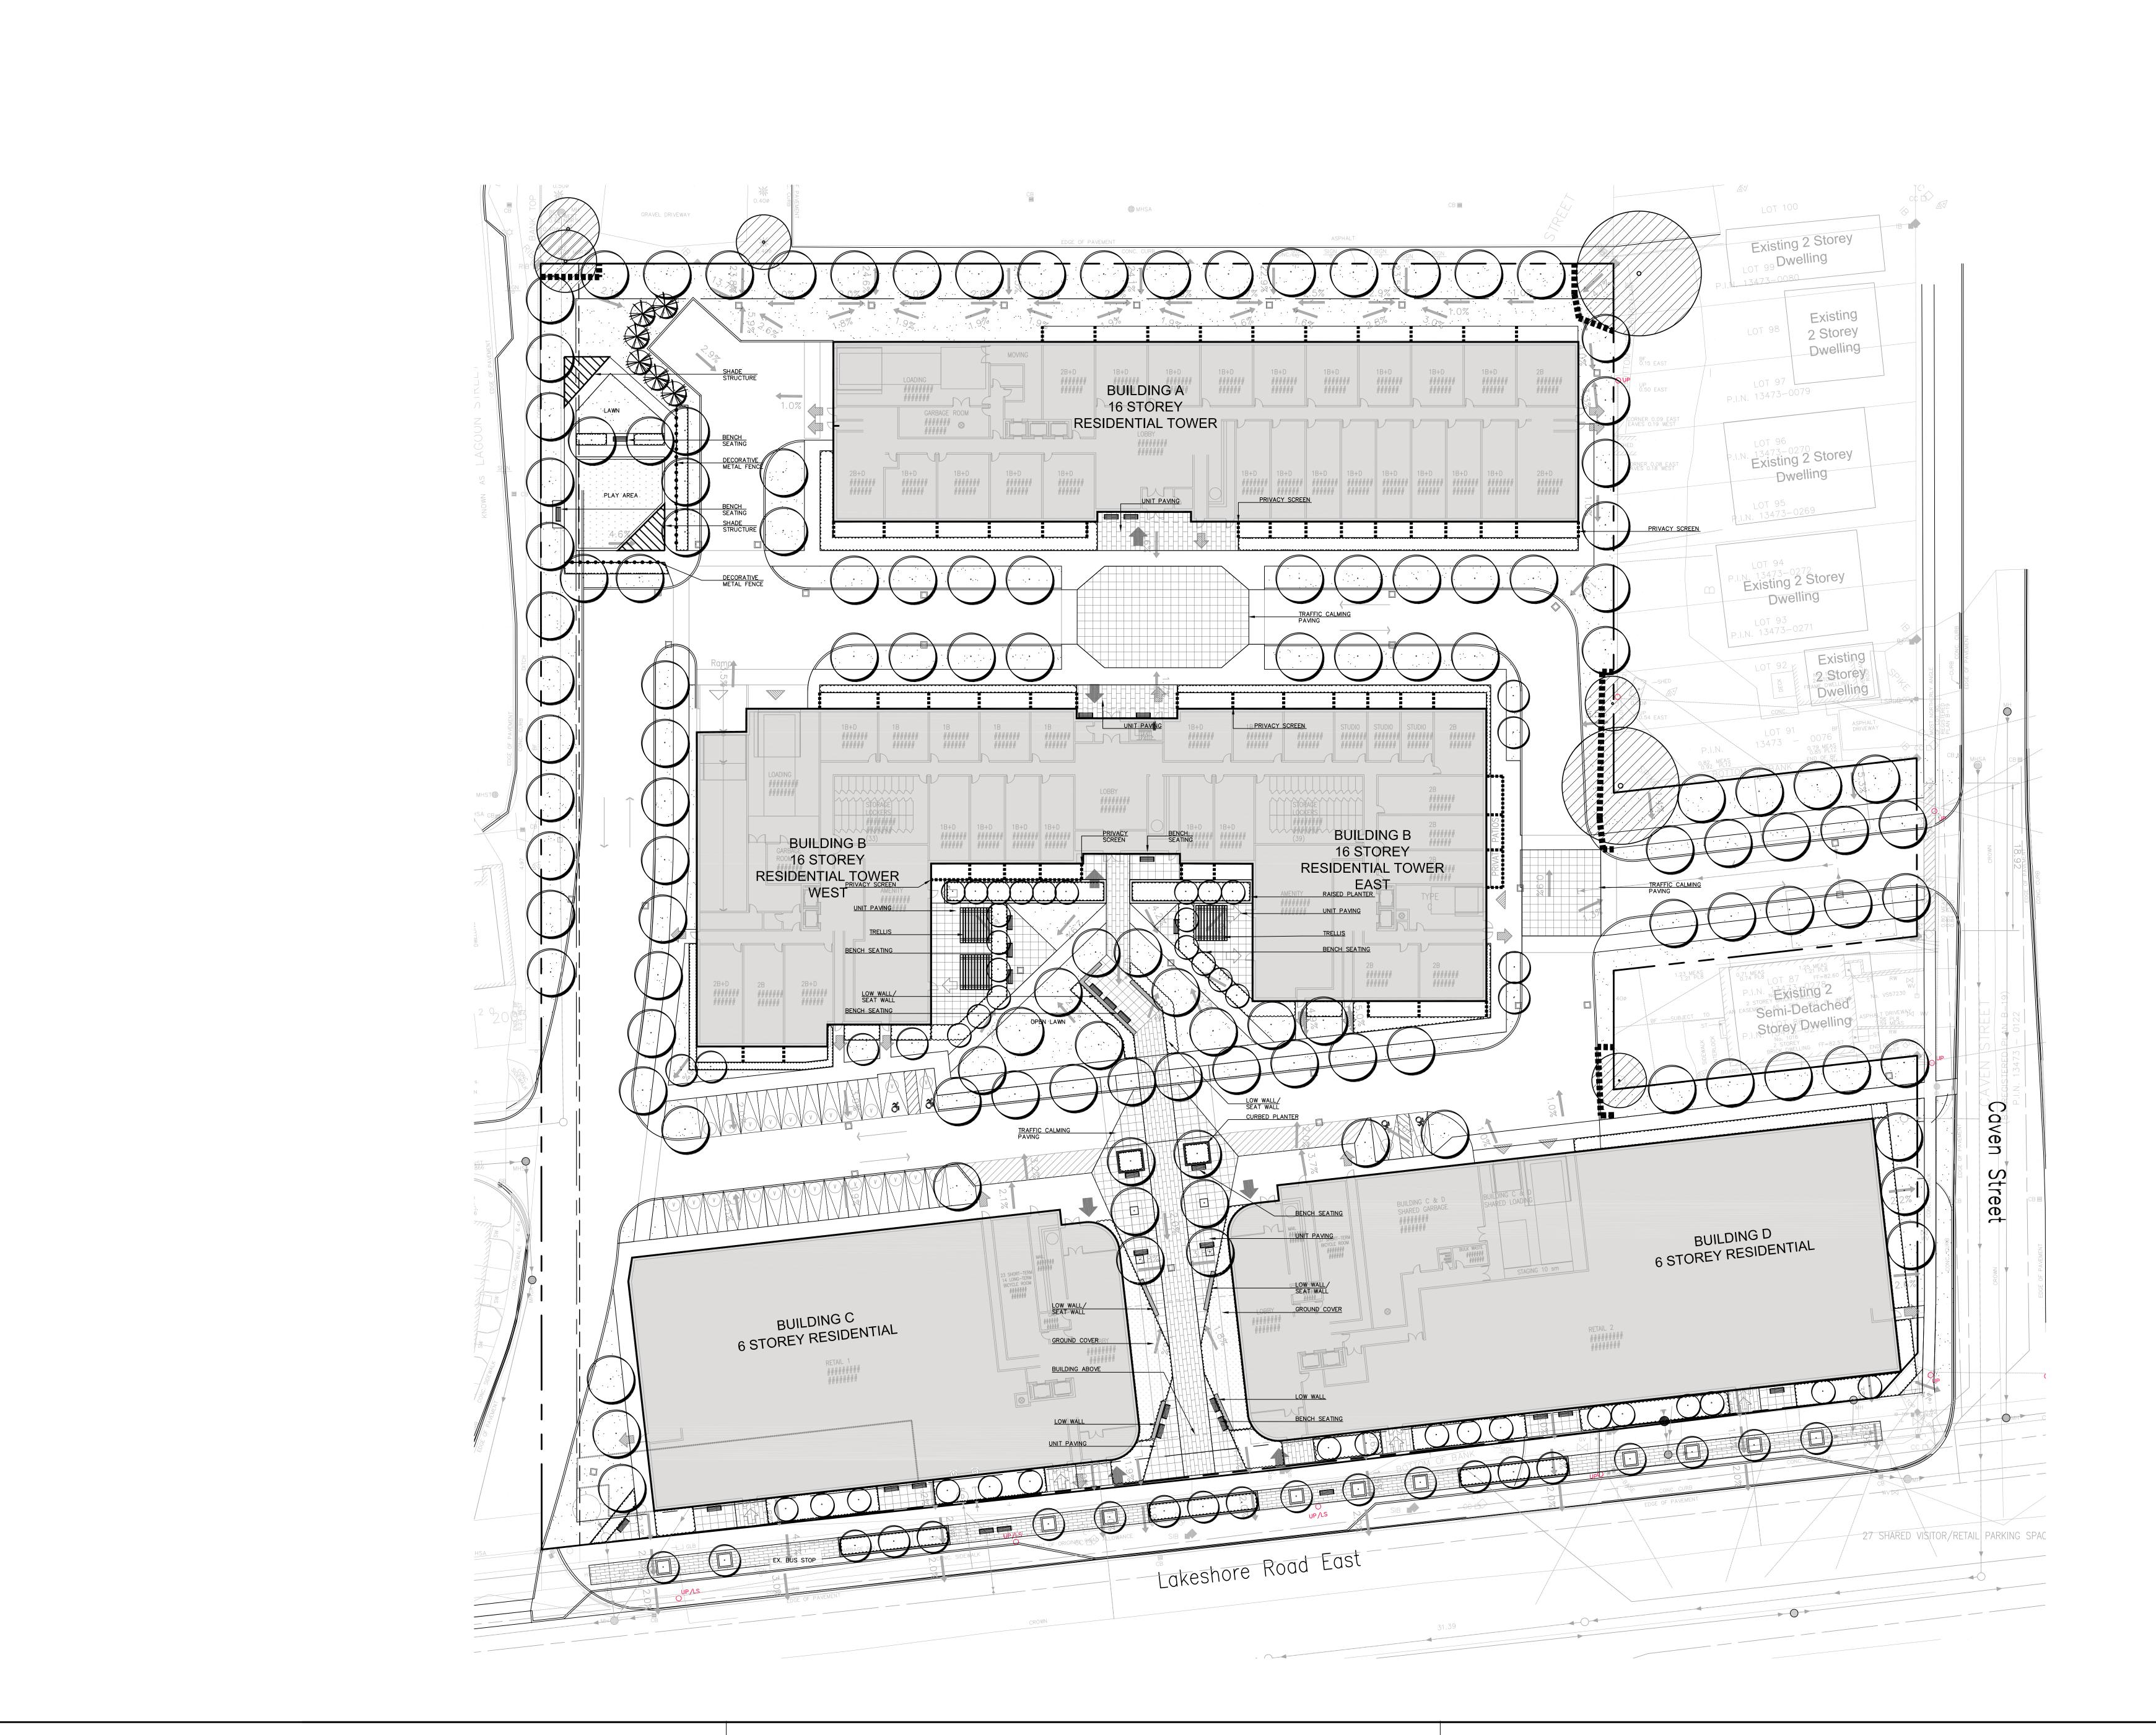VERIFY ALL DIMENSIONS.
DO NOT SCALE DRAWINGS.
REPORT ANY DISCREPANCIES, DISCOVERED ERRORS, OR OMISSIONS TO THE LANDSCAPE ARCHITECT BEFORE PROCEEDING.
IT IS ADVISED THAT CONTRACTORS CONTACT THE LANDSCAPE ARCHITECT PRIOR TO CONSTRUCTION TO ENSURE THE USE OF THE LATEST REVISED DRAWINGS.

DRAWINGS AND SPECIFICATIONS ARE THE PROPERTY OF THE LANDSCAPE ARCHITECT.

KEYMAP



LEGEND

PROPOSED DECIDUOUS TREE

EXISTING TREES TO BE PRESERVED

PROPOSED CONIFEROUS TREE

PROPOSED SHRUBS

PROPOSED GROUND COVER

SODDING

DECORATIVE UNIT PAVING

BBBBBB 1.8m HT. WOOD PRIVACY SCREEN

DECORATIVE METAL FENCE


BENCH SEATING

LOW WALL/ SEAT WALL

RAISED PLANTER

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No.	DATE.	REVISION.	

It is the responsibility of the Contractor and/or Owner to ensure that the drawings with the latest revisions are used for construction.

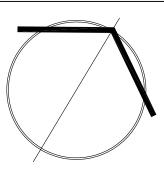



STRYBOS BARRON KING LANDSCAPE ARCHITECTURE

PROPOSED MIXED-USE
RESIDENTIAL DEVELOPMENT
579, 619 Lakeshore Road E
+ 1022, 1028 Caven Street
Mississauga, Ontario
THE BREDA GROUP

DRAWING TITLE.

PRELIMINARY LANDSCAPE CONCEPT PLAN

DATE. NOVEMBER 2021 PROJECT No. 5559

DRAWN BY. S.D. K.L. DRAWING No.

CHECKED BY. M.G. J.B. L100