

NOTES: Tree locations not surveyed, locations are field measured by e arborist. Work location estimated from clients provided site plan


contains information licensed under the Open Government Licence oronto.

- All field data have been recorded by Adam Mohamed ISA Certified Arborist® ON-2333A. All tree locations are based on the survey supplied by the client and field observation by the arborist
- This plan shall be used in conjunction with the Tree Protection Action Key (TPAK). Specific information regarding tree species condition, and protection protocols are listed therein.
- Refer to the Arborist Report prepared for this project for specific instruction regarding tree protection requirements



Y .

No.	DATE	BY	REVISIONS
1	6/24/2022	JS	Initial Tree Inventory
2	8/22/2022	JS	Final Site Plan
3	10/14/2022	JS	Updates

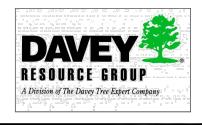

**Pre-Construction Assessment** 4094 Tomken Rd, Mississauga, ON, L4W 4H5

TITLE:

CLIENT: Carly Forrester DRAWING NO .: SCALE: 1:600 001 JOB NO.: SHEET: 1 of 3

EXISTING TREE TO BE REMOVED (PERMIT REQUIRED) EXISTING TREE (UNDERSIZED - NO PERMIT REQUIRED) EXISTING DECIDUOUS TREE EXISTING CONIFEROUS TREE TREE PROTECTION ZONE FENCING PROPERTY LINE UNDERGROUND GARAGE OUTLINE 2022-10-07 ISSUED FOR ZBA 2022-08-19 ISSUED FOR COOR Janet Rosenber GStin UNITED PROPERTY RESOURCE CORPORATION UPRC WESTMINSTER UNITED CHURCH 4094 Tomken Rd, Mississauga, ON L4W 1J5 TREE PRESERVATION PLAN 1.25 RM WS L001

NG AND THE INFORMATION CONTAIN

e Minimum) /Ing, to have dtance of at


Tree Map Number	Species	Botanical	DBH (cm) @ 1.4 m	Tree Ownership	Minimum Tree Protection Distance (m)	Health	Structure	Overall Condition	Tree Height (m)	Crown Width (m)	Live Crown Ratio (%)	Deadwood (%)	Construction inside Min TPZ? (Y/N)	Construction Impact (None, Low, Medium, High)	Action	Permit Required? (YN)	Observations and Recommendations
101	Sugar Maple	Acer saccharum	30	Boundary	1.8	G	G	G	12.2	9.1	100	0	N	L	Preserve	Ν	Tag#101, TPF
102	Austrian Pine	Pinus nigra	30	Boundary	1.8	G	G	G	12.2	9.1	100	0	N	L	Preserve	N	Tag#102 TPF
103	Austrian Pine	Pinus nigra	52	Private	3.6	G	G	G	12.2	6.1	100	0	N	L	Preserve	N	Tag#103 TPF
104	Austrian Pine	Pinus nigra	22	Private	1.8	G	G	G	12.2	9.1	100	0	Ν	L	Preserve	Ν	Tag#104 TPF
105	Austrian Pine	Pinus nigra	22	Private	1.8	G	G	G	12.2	9.1	100	0	Y	L	Injure	Y	hand-dig or hydro-vac to excavate parking
																	lot edge, arborist root pruning
106	Austrian Pine	Pinus nigra	20	Private	1.5	G	G	G	12.2	6.1	100	0	N	L	Preserve	Ν	Tag#106 TPF
107	Colorado Blue Spruce	Picea pungens	31	Private	2.4	G	G	G	15.2	9.1	100	0	Y	н	Remove	Y	Tag#107
108	HoneyLocust	Gleditsia triacanthos	16	Private	1.5	G	G	G	6.1	9.1	100	0	Y	Н	Remove	Y	Tag#108
109	HoneyLocust	Gleditsia triacanthos	16	Private	1.5	G	G	G	6.1	9.1	100	0	Y	Η	Remove	Y	Tag#109
110	HoneyLocust	Gleditsia triacanthos	14	Private	1.5	G	G	G	6.1	9.1	100	0	Y	Н	Remove	Y	Tag#110
111	HoneyLocust	Gleditsia triacanthos	15	Private	1.5	G	G	G	6.1	9.1	100	0	Y	н	Remove	Y	Tag#111
112	HoneyLocust	Gleditsia triacanthos	13	Private	1.5	G	F	F	6.1	9.1	70	30	Y	Н	Remove	Y	Tag#112, one dead branch
113	HoneyLocust	Gleditsia triacanthos	26	Private	1.8	G	F	F	9.1	9.1	100	0	Y	Н	Remove	Y	Tag#113, abnormal root flare growth
114	Colorado Blue Spruce	Picea pungens	20	Neighbour	1.5	G	F	F	15.2	9.1	70	30	N	L	Preserve	N	Estimated DBH, needles missing
115	Common buckthorn	Rhamnus carthartica	10	Neighbour	1.5	G	G	G	3	9.1	100	0	N	L	Preserve	N	Estimated DBH
116	Common buckthorn	Rhamnus carthartica	10	Neighbour	1.5	G	G	G	3	9.1	100	0	N	L	Preserve	N	Estimated DBH
117	Manitoba maple	Acer negundo	10	Neighbour	1.5	G	G	G	3	9.1	100	0	N	L	Preserve	N	Estimated DBH
118	Eastern White cedar	Thuja occidentalis	10	Neighbour	1.5	G	G	G	6.1	9.1	100	0	N	L	Preserve	N	Estimated DBH, 2 stem hedgerow (5-10 cm DBH)
119	Cherry	Prunus species	11	Neighbour	1.5	G	G	G	9.1	9.1	100	0	N	L	Preserve	Ν	Estimated DBH
120	Colorado Blue Spruce	Picea pungens	11	Neighbour	1.5	G	G	G	9.1	9.1	100	0	N	L	Preserve	N	Estimated DBH
121	HoneyLocust	Gleditsia triacanthos	12	Neighbour	1.5	G	G	G	6.1	9.1	100	0	N	L	Preserve	Ν	Estimated DBH
122	HoneyLocust	Gleditsia triacanthos	30	Neighbour	1.8	G	G	G	12.2	9.1	100	0	N	L	Preserve	Ν	Estimated DBH
123	Cherry	Prunus species	20	Neighbour	1.5	G	G	G	12.2	9.1	100	0	N	L	Preserve	Ν	Estimated DBH
124	Colorado Blue Spruce	Picea pungens	22	Neighbour	1.8	G	G	G	15.2	9.1	100	0	Ν	L	Preserve	N	Estimated DBH
125	Colorado Blue Spruce	Picea pungens	22	Neighbour	1.8	G	G	G	15.2	9.1	100	0	N	L	Preserve	N	Estimated DBH
126	Colorado Blue Spruce	Picea pungens	25	Neighbour	1.8	G	G	G	15.2	9.1	100	0	N	L	Preserve	Ν	Estimated DBH
127	HoneyLocust	Gleditsia triacanthos	12	Private	1.5	P	P	Р	6.1	9.1	60	40	Y	Н	Remove	Y	Tag#127, dieback in top of crown
128	Wiilow	Salix species	32	Private	2.4	G	G	G	9.1	9.1	100	0	Y	H	Remove	Y	Tag#128
129	Wiilow	Salix species	29	Private	1.8	G	F	F	9.1	9.1	100	0	Y	н	Remove	Y	Tag#129, multistem (18, 23), missing leaves, trunk wound
130	HoneyLocust	Gleditsia triacanthos	32	Private	2.4	G	G	G	12.2	9.1	100	0	Y	н	Remove	Y	Tag#130
131	HoneyLocust	Gleditsia triacanthos	36	Private	2.4	G	G	G	12.2	9.1	100	0	Y	н	Remove	Y	Tag#131
132	HoneyLocust	Gleditsia triacanthos	36	Private	2.4	G	G	G	12.2	9.1	100	0	Y	н	Remove	Y	Tag#132
133	HoneyLocust	Gleditsia triacanthos	25	Private	1.8	G	G	G	12.2	9.1	100	0	Y	н	Remove	Y	Tag#133
134	HoneyLocust	Gleditsia triacanthos	30	Private	1.8	G	G	G	12.2	9.1	100	0	Y	Н	Remove	Y	Tag#134
135	HoneyLocust	Gleditsia triacanthos	26	Private	1.8	G	G	G	12.2	9.1	100	0	Y	H	Remove	Y	Tag#135
136	HoneyLocust	Gleditsia triacanthos	39	Private	2.4	G	G	G	12.2	9.1	100	0	Y	Н	Remove	Y	Tag#136
137	English oak	Quercus robur	41	Private	3.0	G	G	G	18.3	9.1	100	0	Y	м	Injure	Y	Hand digging for new pathways, arborist
138	Pear	Pyrus sp	17	Private	1.5	F	F	F	15.2	9.1	70	30	Y	н	Remove	Y	root pruning Tag#138, Multistem (17, 8), one stem dead
139	Pear	Pyrus sp	11	Private	1.5	F	F	F	15.2	9.1	70	30	Y	н	Remove	Y	Tag#139, Multistem (11, 8, 10)
																Y	Hand digging for new pathways, arborist
140	English oak	Quercus robur	43	Private	3.0	G	G	G	18.3	9.1	100	0	Y	М	Injure		root pruning
141	Norwaymaple	Acer platanoides	23	Boundary	1.8	G	G	G	12.2	9.1	100	0	Y	H	Remove	Y	Tag#141
142	Colorado Blue Spruce	Picea pungens	22	Private	1.8	F	F	F	15.2	9.1	70	30	Y	H	Remove	Y	Tag#142, missing leaves TPF
143	Colorado Blue Spruce	Picea pungens	25 23	Private	1.8	G	G	G	15.2	9.1 9.1	100 70	0	Y	H H	Remove	Y	Tag#143 TPF
144	Norway maple	Acer platanoides		Private	1.8		G		12.2			30	Y		Remove	Y	Tag#144, missing leaves, trunk damage
145 146	Sugar Maple Sugar Maple	Acer saccharum Acer saccharum	25 21	Private Private	1.8	G	G	G	12.2	9.1 9.1	100	0	Y	H H	Remove Remove	Y	Tag#145 Tag#146
140	Sugar Maple	Acer saccharum	17	Private	1.5	G	G	G	12.2	9.1	100	0	Y	н	Remove	Y	Tag#147
148	Sugar Maple	Acer saccharum	28	Private	1.8	G	G	G	12.2	9.1	100	0	Y	н	Remove	Y	Tag#148
149	Lilac species	Syringa species	21	Private	1.8	G	G	G	12.2	9.1	100	0	Y	H	Remove	Y	Tag#149, Multistem (13, 9, 9, 10)
150	Lilac species	Syringa species	13	Private	1.5	G	G	G	12.2	9.1	100	0	Y	н	Remove	Y	Tag#150
151	Lilac species	Syringa species	16	Private	1.5	G	G	G	12.2	9.1	100	0	Y	н	Remove	Y	Tag#151, Multistem (14, 8)
152	Pear	Pyrus species	20	Private	1.5	G	G	G	9.1	9.1	100	0	Y	Н	Remove	Y	Estimated DBH
153	White pine	Pinus strobus	22	Private	1.8	G	G	G	12.2	9.1	70	30	Y	н	Remove	Y	Tag#153, missing needles;
154	Freeman maple	Acer x Freemani	10	Private	1.5	G	G	G	9.1	9.1	100	0	Y	Н	Remove	Y	Tag#154
155	Cherry	Prunus species	20	Private	1.5	G	G	G	9.1	9.1	100	0	N	L	Preserve	Ν	Estimated DBH
156	Crabapple	Malus sylvestris	13	Private	1.5	G	G	G	9.1	9.1	100	0	Ν	L	Preserve	N	Estimated DBH, Multistem (10, 3, 8)
157	Crabapple	Malus sylvestris	16	Private	1.5	G	G	G	9.1	9.1	100	0	N	L	Preserve	Ν	Estimated DBH, Multistem (10, 8, 10)
158	Pear	Pyrus species	17	Private	1.5	G	G	G	9.1	9.1	100	0	N	L	Preserve	Ν	Tag#158, Multistem (14, 10)
159	Crabapple	Malus sylvestris	26	Private	1.8	G	G	G	9.1	9.1	100	0	Y	Н	Remove	Y	Tag#159
160	Juniper	Juniperus species	11	Private	1.5	G	G	G	9.1	9.1	100	0	Y	Н	Remove	Y	Estimated DBH
161	Colorado Blue Spruce	Picea pungens	32	Private	2.4	G	G	G	15.2	9.1	100	0	Y	L	Injure	Y	Hand digging for new pathways, arborist root pruning
162	White spruce	Picea glauca	18	Private	1.5	F	F	F	15.2	9.1	70	30	Y	м	Injure	Y	Hand digging for new pathways, arborist
152	same spince		10	. mate	1.0								1	144	jure		root pruning
163	Colorado Blue Spruce	Picea pungens	27	Private	1.8	F	F	F	15.2	9.1	70	30	Y	L	Injure	Y	Hand digging for new pathways, arborist root pruning
164	HoneyLocust	Gleditsia triacanthos	25	Neighbour	1.8	G	G	G	12.2	9.1	100	0	Ν	L	Preserve	Ν	Estimated DBH
165	HoneyLocust	Gleditsia triacanthos	25	Neighbour	1.8	G	F	F	12.2	9.1	70	30	N	L	Preserve	N	Estimated DBH, missing leaves
166	HoneyLocust	Gleditsia triacanthos	25	Neighbour	1.8	G	G	G	12.2	9.1	100	0	N	L	Preserve	N	Estimated DBH
167	HoneyLocust	Gleditsia triacanthos	25	Neighbour	1.8	G	F	F	12.2	9.1	70	30	N	L	Preserve	Ν	Estimated DBH, missing leaves
168	HoneyLocust	Gleditsia triacanthos	25	Neighbour	1.8	G	G	G	12.2	9.1	100	0	N	L	Preserve	N	Estimated DBH
169	White mulberry	Morus alba	15	Neighbour	1.5	G	G	G	6.1	9.1	100	0	N	L	Preserve	N	Estimated DBH
170	HoneyLocust	Gleditsia triacanthos	25 10	Neighbour	1.8 1.5	G	G	G	12.2 9.1	9.1 9.1	100	0	N	L	Preserve	N	Estimated DBH
1/1	Colorado Blue Spruce HoneyLocust	Picea pungens Gleditsia triacanthos	25	Neighbour Neighbour	1.5	G	G	G	9.1	9.1	100	0	N N	L	Preserve Preserve	N	Estimated DBH Estimated DBH
172	HoneyLocust	Gleditsia triacanthos	30	Neighbour	1.0	P	P	P	12.2	9.1	50	50	N	L	Preserve	N	Estimated DBH, half of tree without leaves
174	Austrian Pine	Pinus nigra	22	Private	1.8	G	G	G	9.1	9.1	100	0	Y	L	Injure	Y	Multistem (14, 17); hand-dig or hydro-vac to excavate parking lot edge, arborist root pruning
175	Austrian Pine	Pinus nigra	23	Private	1.8	G	G	G	12.2	9.1	100	0	N	L	Preserve	N	Tag#175 TPF
176	Littleleaflinden	Tilia cordata	44	Private	3.0	G	G	G	12.2	9.1	100	0	N	L	Preserve	N	Tag#176 TPF
177	Lilac species	Syringa species	10	Private	1.5	G	G	G	6.1	9.1	100	0	Y	н	Remove	Y	Tag#177
178	Littleleaflinden	Tilia cordata	34	Private	2.4	G	G	G	12.2	9.1	100	0	Y	Н	Remove	Y	Tag#178
			-			_						_					
179	Littleleaflinden	Tilia cordata	28	Private	1.8	G	F	F	12.2	9.1	70	30	Y	Н	Remove	Y	Tag#179, missing leaves

NOTES: Tree locations not surveyed, locations are field measured by the arborist. Work location estimated from clients provided site plan.

Contains information licensed under the Open Government Licence - Toronto.


- All field data have been recorded by Adam Mohamed ISA Certified Arborist® ON-2333A. All tree locations are based on the survey supplied by the client and field observation by the arborist.
- This plan shall be used in conjunction with the Tree Protection Action Key (TPAK). Specific information regarding tree species, condition, and protection protocols are listed therein.

Refer to the Arborist Report prepared for this project for specific instruction regarding tree protection requirements.

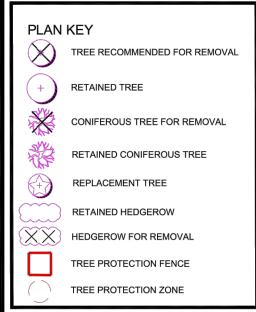




No.	DATE	BY	REVISIONS
1	6/24/2022	JS	Initial Tree Inventory
2	8/22/2022	JS	Final Site Plan
3	10/14/2022	JS	Updates

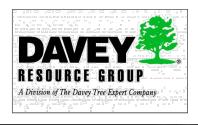

TITLE:

Pre-Construction Assessment 4094 Tomken Rd, Mississauga, ON, L4W 4H5

CLIENT: Carly Fo	rrester	
DRAWING NO.: 001	SCALE: 1:600	)
JOB NO.:	SHEET: 2 of 3	3

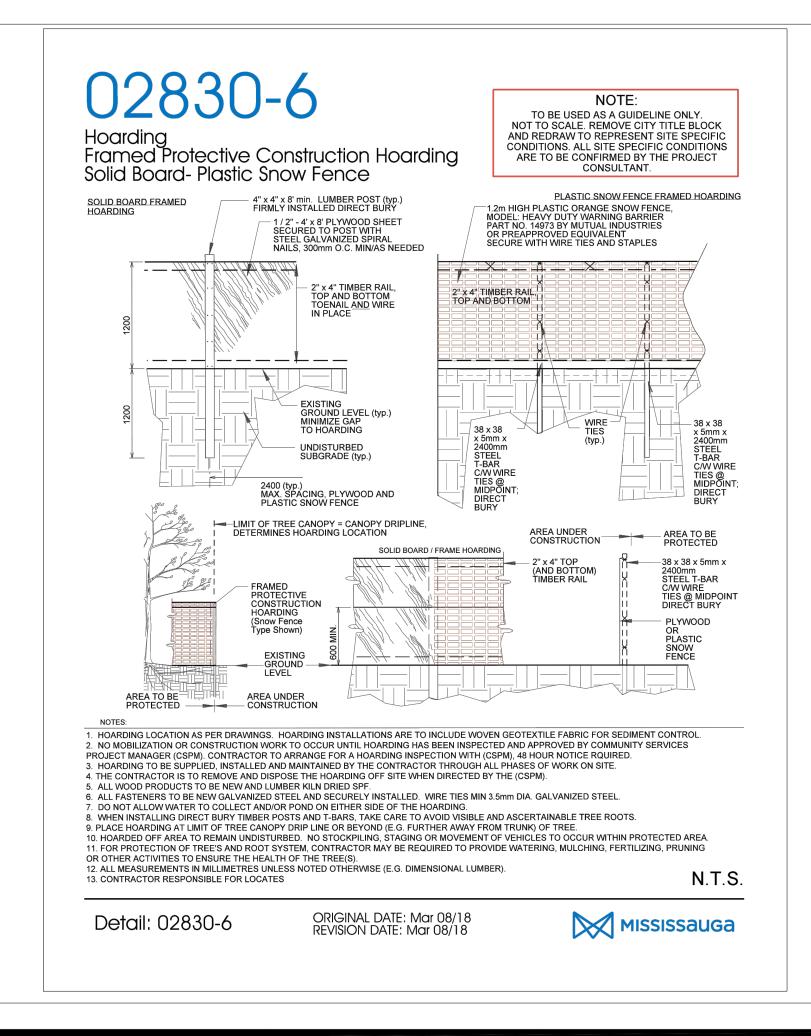


NOTES: Tree locations not surveyed, locations are field measured by the arborist. Work location estimated from clients provided site plan.


Contains information licensed under the Open Government Licence – Toronto.

- All field data have been recorded by Adam Mohamed ISA Certified Arborist® ON-2333A. All tree locations are based on the survey supplied by the client and field observation by the arborist.
- This plan shall be used in conjunction with the Tree Protection Action Key (TPAK). Specific information regarding tree species, condition, and protection protocols are listed therein.

Refer to the Arborist Report prepared for this project for specific instruction regarding tree protection requirements.

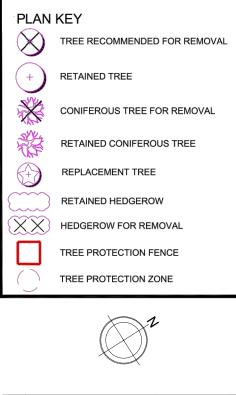

No.	DATE	BY	REVISIONS
1	6/24/2022	JS	Initial Tree Inventory
2	8/22/2022	JS	Final Site Plan
3	10/14/2022	JS	Updates

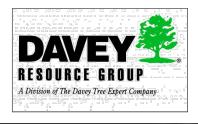

TITLE:

Pre-Construction Assessment 4094 Tomken Rd, Mississauga, ON, L4W 4H5

CLIENT: Carly Fo	rrester	
DRAWING NO.: 001	SCALE:	1:600
JOB NO.:	SHEET:	3 of 3