

- LEGEND**
- EXISTING DECIDUOUS TREE TO REMAIN
 - EXISTING DECIDUOUS TREE TO BE REMOVED
 - TREE PROTECTION SOLID HOARDING (Private Lands) PER CITY OF MISSISSAUGA STANDARDS THE FINAL LOCATION OF THE EXTENT OF PROPOSED TREE PROTECTION FENCING WILL BE CO-ORDINATED WITH THE ENGINEER AND ARBORIST TO ENSURE THAT DAMAGE TO EXISTING TREES IS MINIMIZED DURING CONSTRUCTION.
 - PROPERTY LINE
 - TREE IDENTIFICATION KEY (TREES TO BE RETAINED)
 - TREE IDENTIFICATION KEY (TREES TO BE REMOVED)

- GENERAL NOTES**
1. Do not scale the drawings. All dimensions are in millimetres unless noted otherwise.
 2. This drawing is to be read in conjunction with the project site plan, landscape plan, and engineering plan.
 3. The tree inventory includes assessment of trees >10cm DBH. The trees have been assessed based on species, size and condition.
 4. The contractor shall check and verify all existing and proposed grading and conditions on the project and immediately report any discrepancies to the consultant before proceeding with any removals.
 5. The contractor is to be aware of all existing and proposed services and utilities. The contractor is responsible for having all underground services and utility lines staked by each agency having jurisdiction prior to commencing work.
 6. This drawing is to be used for development approval only.
 7. Do not leave any holes open overnight.
 8. Keep area outside construction zone clean and useable by others at all times. Contractor shall thoroughly clean areas surrounding the construction zone at the end of each work day.
 9. Contractor to make good any and all damages outside of the development area that may occur as a result of tree removals at no extra cost.
 10. This drawing is Copyright MHBC Planning, 2020.

REVISION NO.	DATE	ISSUED / REVISION	BY
5.	NOVEMBER 4, 2022	RE-ISSUED FOR SPA	MB
4.	NOVEMBER 20, 2020	ISSUED FOR SPA	TT
3.	NOVEMBER 13, 2020	ISSUED FOR REVIEW	HH
2.	OCTOBER 14, 2020	ISSUED FOR REVIEW	HH
1.	SEPTEMBER 11, 2020	ISSUED FOR REVIEW	HH

MHBC
PLANNING
URBAN DESIGN
& LANDSCAPE
ARCHITECTURE

230-7050 WESTON ROAD WOODBRIDGE, ON, L4L 8G7 | P: 905 761 5588 F: 905 761 5589 | WWW.MHBCPLAN.COM

STAMP

ISSUED FOR SPA ONLY
NOT FOR CONSTRUCTION

All drawings and specifications are instruments of service and will remain the property of MHBC Planning and must be returned at the completion of the work. This drawing shall not be used for construction purposes unless the drawings are marked 'Issued for Construction' and the professional seal is signed and dated by the landscape architect.

DATE AUGUST 2020

DRAWN BY H.H.

PLAN SCALE 1:300

FILE NO. 1625TAG

CHECKED BY N.M.

OTHER

PROJECT


6333 HURONTARIO STREET
MISSISSAUGA, ONTARIO

FILE NAME

**TREE INVENTORY,
PROTECTION, AND
REMOVALS**

DWG NO.

TI-1

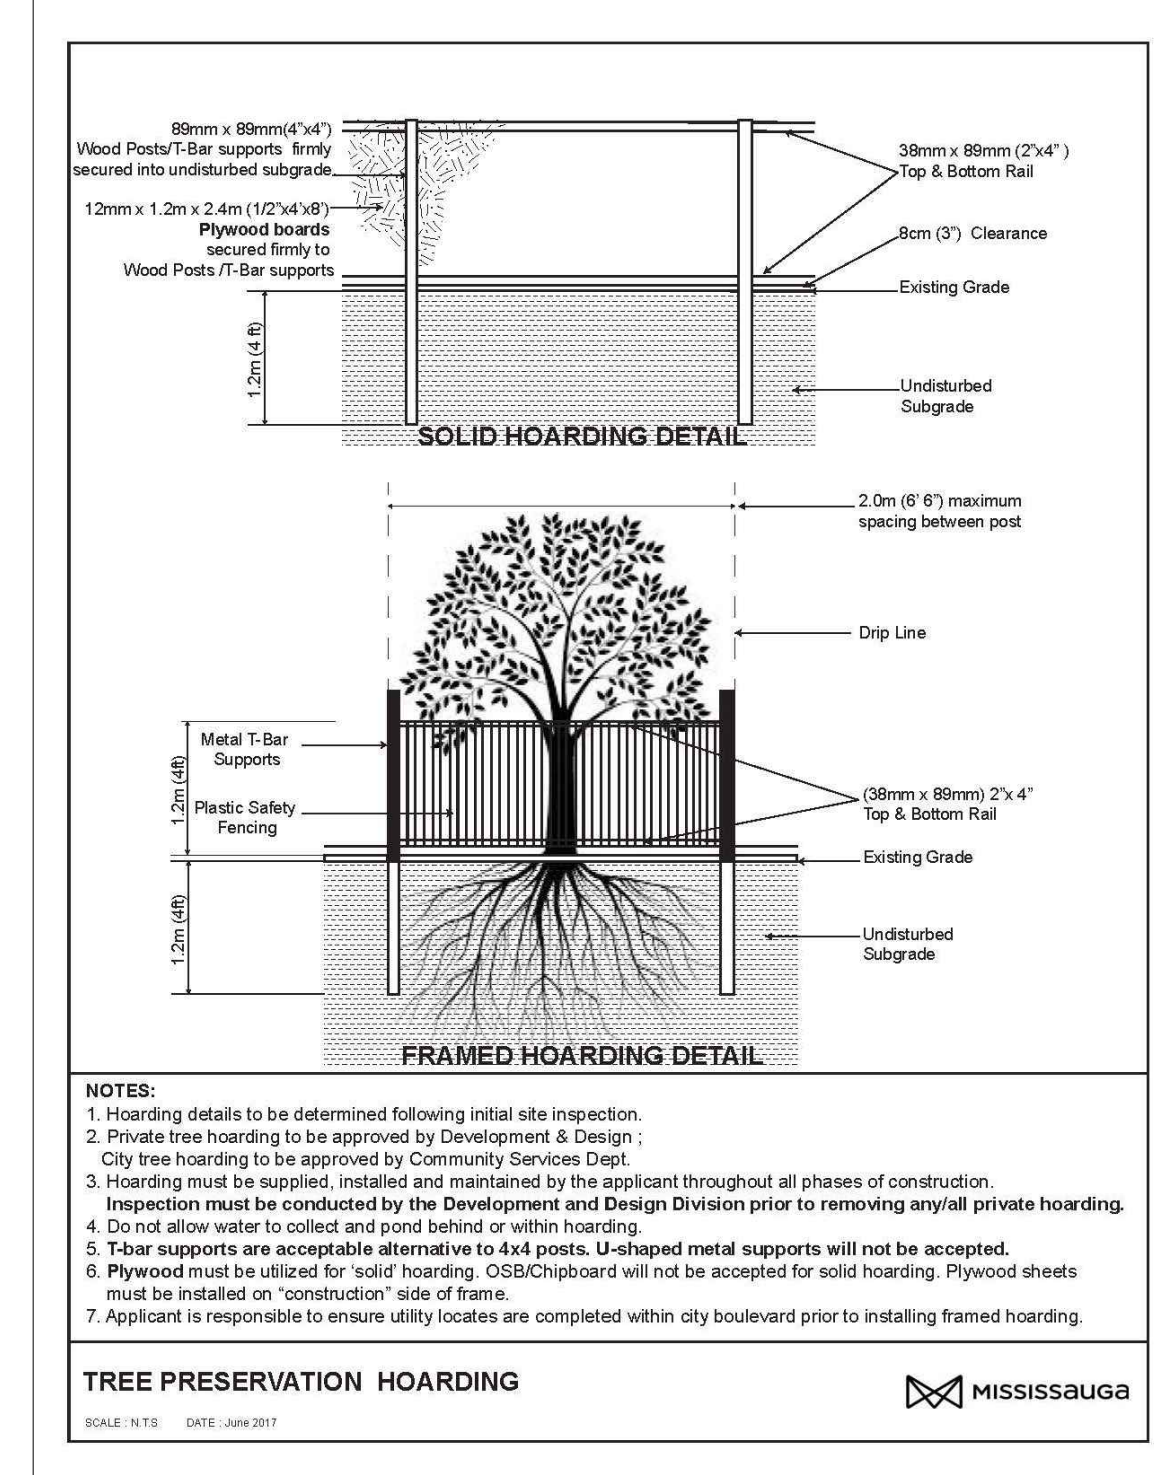

TREE INVENTORY NOTES

ID	Species	Common Name	DBH (cm)	Height (m)	Condition	Notes	Count	Action
1	Little Leaf Linden	Tilia cordata	34	F/G		Vines growing on tree	0	Retain
2	Little Leaf Linden	Tilia cordata	33	F/G			0	Retain
3	Little Leaf Linden	Tilia cordata	25	F/G			0	Retain
4	Little Leaf Linden	Tilia cordata	24	F/G			0	Retain
5	Little Leaf Linden	Tilia cordata	27	F/G			0	Retain
6	Little Leaf Linden	Tilia cordata	28	F/G			0	Retain
168	Manitoba Maple	Acer negundo	36	F		4 stem, tree showing signs of urban stress	1	Remove
169	Manitoba Maple	Acer negundo	35	F		3 stem, signs of rot in trunk, signs of urban stress	1	Remove
170	Manitoba Maple	Acer negundo	35	F/P		Significant canopy dieback	1	Remove
171	Manitoba Maple	Acer negundo	11	F/G			1	Remove
172	Manitoba Maple	Acer negundo	60	F			2	Remove
173	Manitoba Maple	Acer negundo	11	F		2 stem	1	Remove
174	Manitoba Maple	Acer negundo	15	F		2 stem	1	Remove
175	Manitoba Maple	Acer negundo	120	F		Signs of rot, typical developing structural issues for aging tree	2	Remove
176	Grey Birch	Betula populifolia	35	P			0	Remove
177	Manitoba Maple	Acer negundo	27	F			1	Remove
178	Flowering Crabapple Tree	Malus	31	F/P			1	Remove
179	Manitoba Maple	Acer negundo	19	F			1	Remove
180	Manitoba Maple	Acer negundo	17	F			1	Remove
181	Manitoba Maple	Acer negundo	28	F		3 stem	1	Remove
182	Manitoba Maple	Acer negundo	30	F			1	Remove
183	Manitoba Maple	Acer negundo	27	F		3 stem	1	Remove
184	Manitoba Maple	Acer negundo	22	F		3 stem	1	Remove
185	Manitoba Maple	Acer negundo	28	P/D		95% dead, fruiting bodies present	0	Remove
186	Manitoba Maple	Acer negundo	33	F/P		4 stem, signs for rot in trunk	0	Retain
187	Manitoba Maple	Acer negundo	35	P		Past failures, trunk rot, significant deadwood	0	Retain
188	Manitoba Maple	Acer negundo	39	P		Significant lean, trunk rot	0	Remove
189	Manitoba Maple	Acer negundo	17	F		2 stem, significant lean	1	Remove
190	Manitoba Maple	Acer negundo	11	F		2 stem, moderate lean	1	Remove
191	Manitoba Maple	Acer negundo	13	F		2 stem, moderate lean	1	Remove
192	Manitoba Maple	Acer negundo	13	F		4 stem	1	Remove
193	Manitoba Maple	Acer negundo	14	F		2 stem	1	Remove
194	Manitoba Maple	Acer negundo	10	F			1	Remove
195	Manitoba Maple	Acer negundo	10	F		7 stem	1	Remove
196	Manitoba Maple	Acer negundo	10	F			1	Remove
197	Manitoba Maple	Acer negundo	13	F		3 stem	1	Remove
198	Manitoba Maple	Acer negundo	11	F		2 stem	1	Remove
199	Manitoba Maple	Acer negundo	12	F		3 stem	0	Retain
200	Manitoba Maple	Acer negundo	12	F		5 stem	0	Retain

NOTE:
NEIGHBOUR'S CONSENT WILL BE REQUIRED PRIOR TO THE REMOVAL OF TREE 171.