STREETSCAPING FEASIBILITY STUDY

69 & 117 JOHN STREET

CITY OF MISSISSAUGA REGION OF PEEL

PREPARED FOR: CENTRACONDOS DE LA MONTAGNE

PREPARED BY:

C.F. CROZIER & ASSOCIATES INC. 211 YONGE STREET, SUITE 600 TORONTO, ON M5B 2H1

OCTOBER 2024

CFCA FILE NO. 2378-6557

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Revision Number	Date	Comments
Rev.0	April 24, 2024	Issued for 1st OPA & ZBA Submission
Rev.1	October 16, 2024	Issued for 2 nd OPA & ZBA Submission

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SFS-P: Utility and Streetscape Plan & Sections - Proposed Conditions

LIST OF APPENDICES

23-0179: Subsurface Utility Engineering Investigation (prepared by 4Sight Utility Engineers)

L2-01: Landscape Plans (prepared by MSLA)

LD-01: Landscape Sections (prepared by MSLA)

1.0 Introduction

C.F. Crozier & Associates Inc. (Crozier) was retained by Centracondos de la Montagne to prepare a Streetscaping Feasibility Study. The study will support the applications for the Official Plan Amendment and Zoning By-Law Amendment required to permit the residential development at 69 & 117 John Street in the City of Mississauga, Region of Peel (the Site).

The subject property is approximately 1.63 ha in total and is currently an undeveloped gravel lot. The site is bounded by the Canadian Pacific Railway to the west, an existing residential neighborhood to the north and east and a commercial storage building to the south. The Streetscaping Feasibility Study has been completed for the site as required by the City of Mississauga and is in accordance with the Streetscape Feasibility Terms of Reference, May 2019. The purpose of the study is to demonstrate that the proposed development can accommodate the appropriate boulevard treatment within the public right-of-way and that the associated building setbacks are adequate on John Street.

Enclosed Drawing SFS-P (Streetscape Feasibility Study: Utility & Streetscape Plan Proposed Conditions) reflecting the existing and proposed Utility Plan and Trench Location Plan in accordance with the City of Mississauga for the proposed design on John Street South.

2.0 Existing Utility Plan

The existing utilities along John Street are shown on the drawings is developed from the Sub-Surface Utility Investigation (SUE) Locates by 4Sight Utility Engineers dated February 23rd, 2024.

Two cross-sections have been prepared along John Street to demonstrate the approximate locations of the existing utilities within the John Street right-of-way and the proposed planting soil areas per the Landscape Architect's design. All sections demonstrate above- and below-grade utilities.

The SUE investigation identified the following services and utilities within the of John Street right-of-way:

- 375mm dia. sanitary sewer
- 500mm dia. and 600mm dia. storm sewers
- 150mm dia. and 200mm dia. watermain
- Hydro Line (Alectra)
- Hydro Line (Street Light)
- 100mm gas main

3.0 Trench Location Plan

Drawings SFS-P and L2-01 reflect the tree and tree trench locations along John Street as per the landscape architectural design by Marton Smith Landscape Architects (MSLA). Refer to the Landscape drawing set prepared by MSLA for additional details.

Building limits (both at-grade and below-grade) along John Street are setback at a minimum 3.0m from the proposed soil trench. The setback provides adequate clearance to the subsurface tree trenches which will allow for future maintenance.

The Landscape Architect is responsible to specify trees that adhere to the above-grade street tree canopy clearances as shown in Figure 1 of the Streetscaping Feasibility Terms of Reference. Refer to the Landscape sections plan LD-01 for cross-sections prepared by the Landscape Architect.

4.0 Conclusions

Based on the Streetscaping Feasibility Study, an appropriate boulevard treatment can be accommodated in the John Street right-of-way in accordance with City's streetscape requirements.

Respectfully submitted,

C.F. CROZIER & ASSOCIATES INC.


C.F. CROZIER & ASSOCIATES INC.

Maa Istala

Gamsa Sivanantham, P.Eng. Project Engineer Mena Iskander, P.Eng. Project Engineer

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DRAWINGS

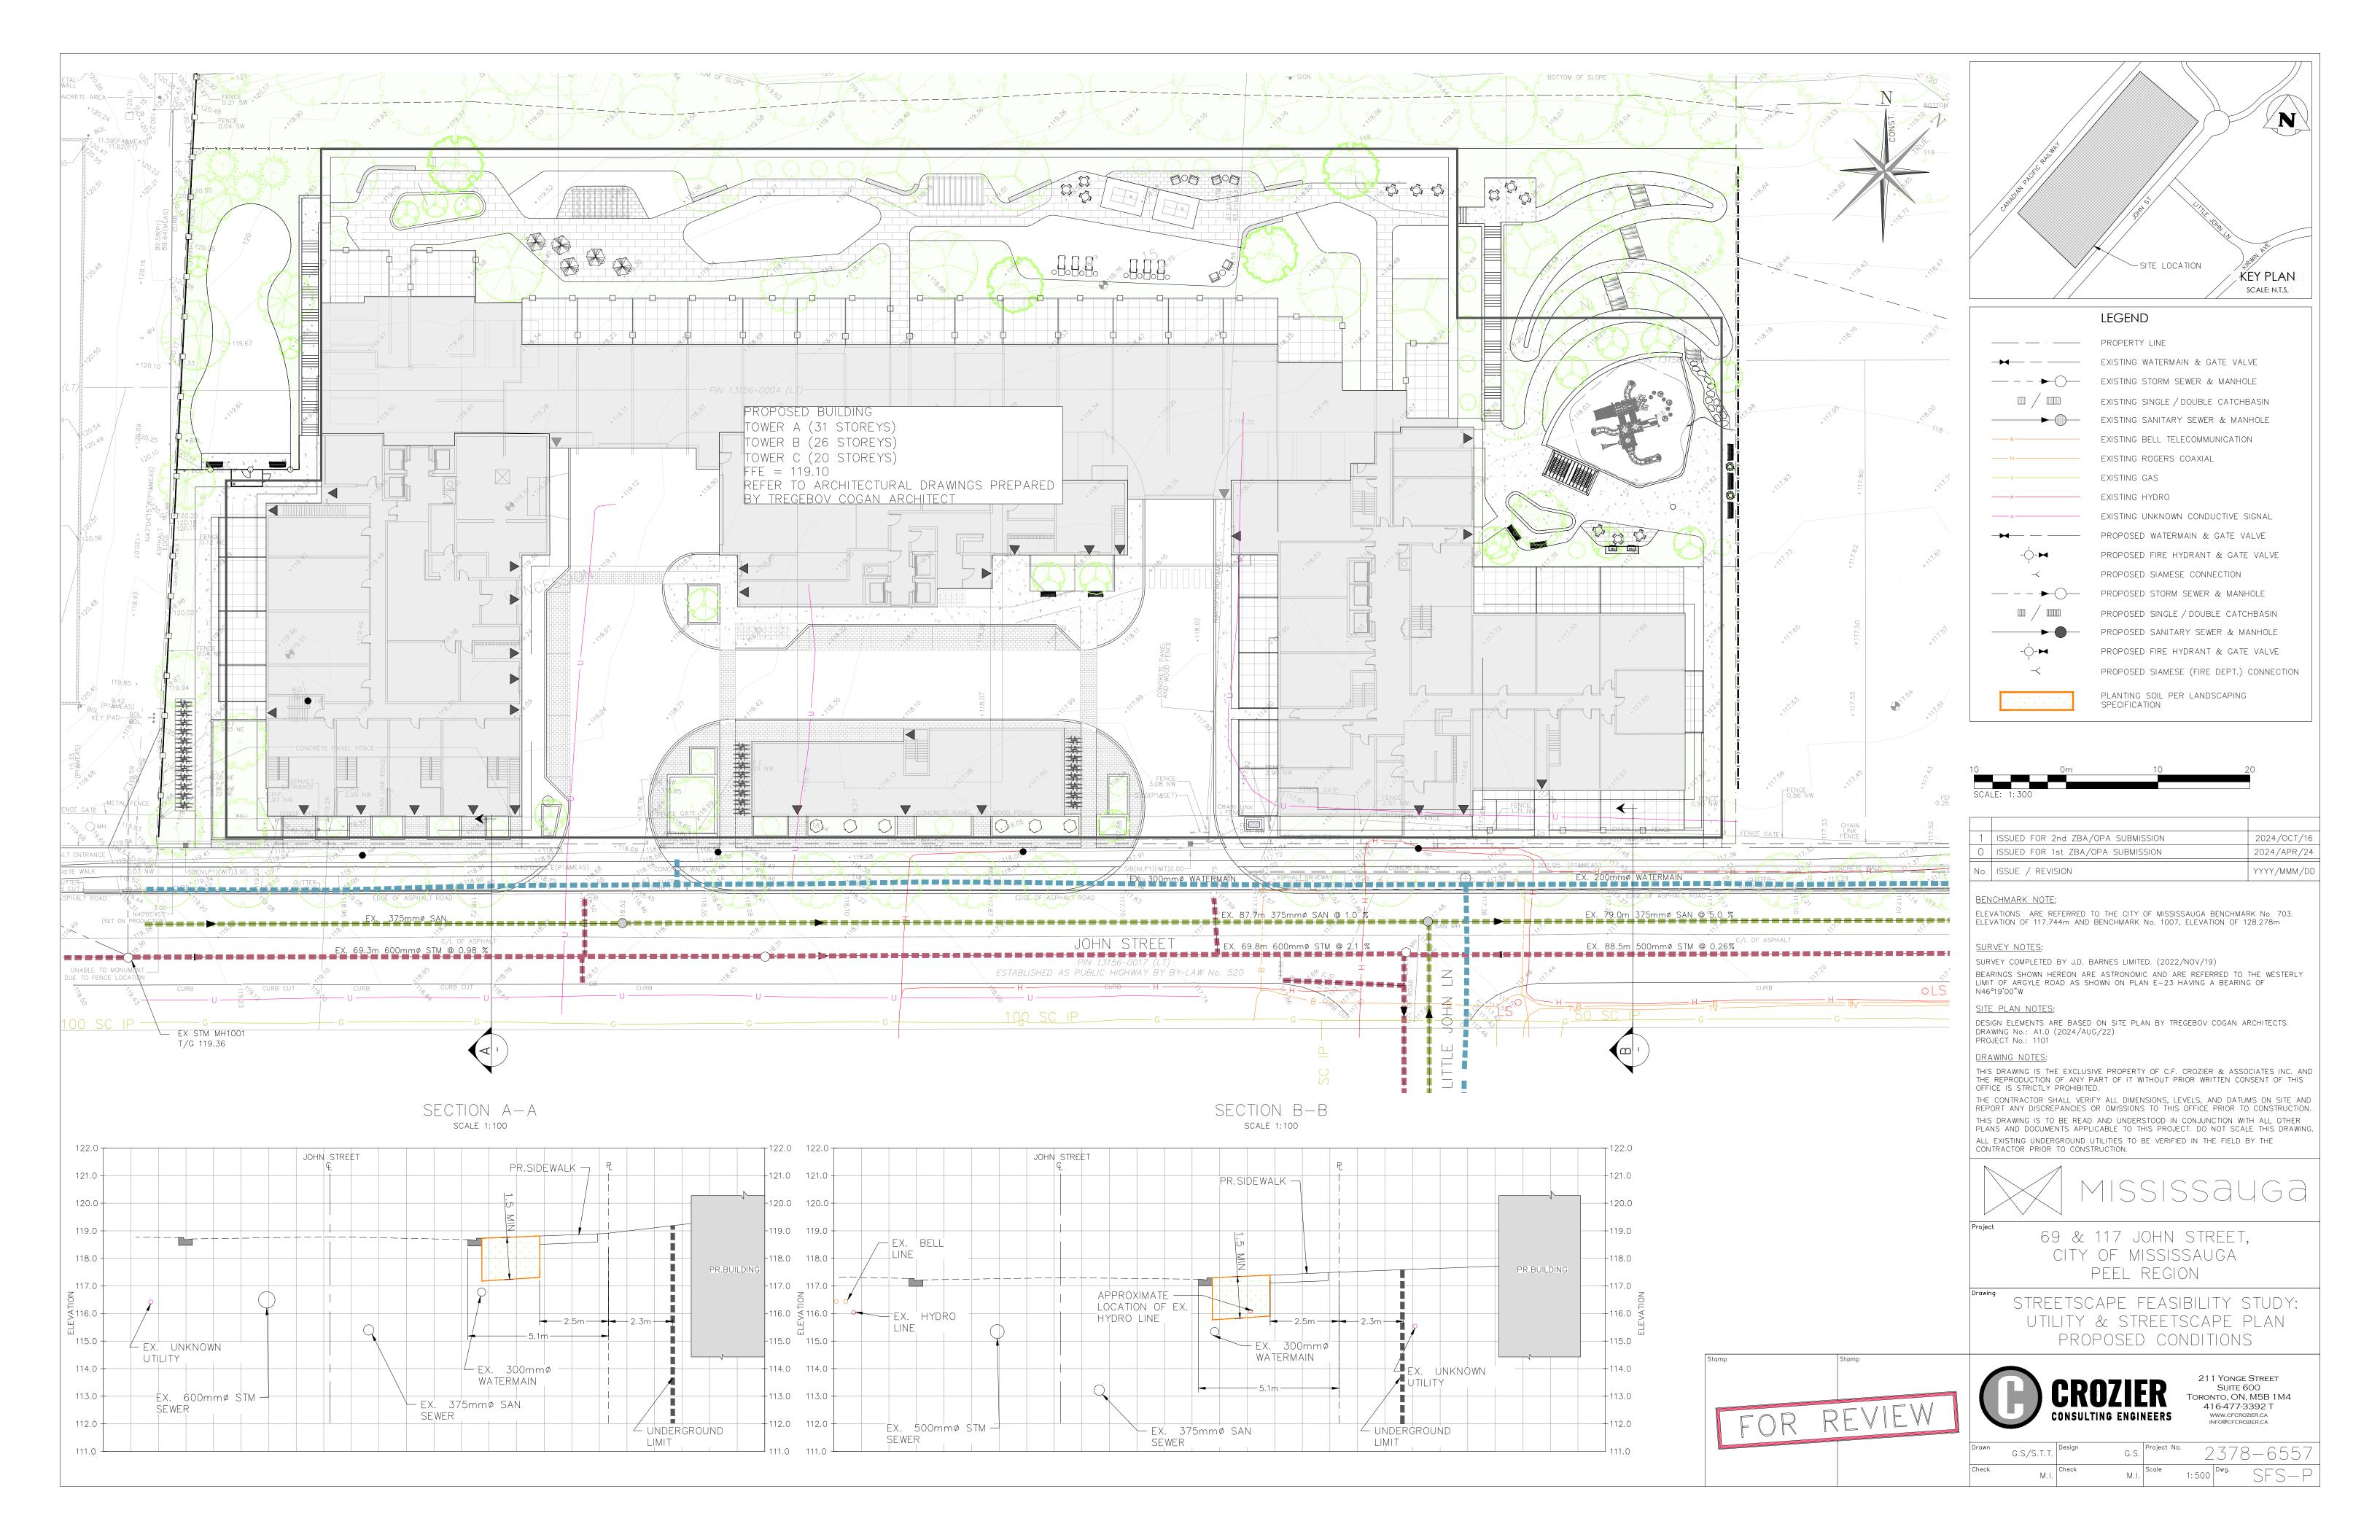

APPENDICES

VOLTARIE CR SHEET JOHN ST BELL RECORDS NOT RECEIVED AT TIME OF INVESTIGATION. BELL WAS NOTIFIED MULTIPLE TIMES FOR REQUEST OF RECORD INFO WITHIN THESE LIMITS. BELL PLANT SHOWN AS FIELD VERIFIED. NOT TO SCALE ` .THE FIELD INVESTIGATION WAS COMPLETED IN JAN 2024. 2.THE LIMITS OF THE INVESTIGATION ARE AS PER SHOWN ON THE DRAWING. 3.THE BASE PLAN FOR THIS DRAWING WAS PROVIDED BY THE CLIENT AND 4SIGHT IS NOT RESPONSIBLE FOR ITS ACCURACY. -CENTURY LINK RECORDS INDICATE A PLANT IN 4.UTILITY SIZES AND MATERIALS ARE SHOWN IF AVAILABLE FROM A NORTH EAST/SOUTH WEST ALIGNMENT AT CANADIAN PACIFIC RAILWAY RECORD INFORMATION. THIS LOCATION. PLANT OUTSIDE OF LIMITS. 5.KNOWN UTILITY OWNERS IDENTIFIED WITHIN PUBLIC RIGHT OF WAY INCLUDE: a.WATER & SANITARY - REGION OF PEEL b.STORM - CITY OF MISSISSAUGA c.ELECTRICAL - ALECTRA d.TELECOM — BELL & ROGERS e.GAS - ENBRIDGE SEE PROJECT REPORT FOR ADDITIONAL DETAILS. BELL TELECOMMUNICATIONS ──── TV ──── ROGERS COAXIAL PRIVATE COMMUNICATIONS ——— FO ———— FIBER OPTIC BELL FIBER OPTIC RF ROGERS FIBER OPTIC ----- CF ----- COGECO FIBER OPTIC ZF ZAYO FIBER OPTIC H HYDRO STREETLIGHT TL TRAFFIC LIGHT -ENBRIDGE RECORDS INDICATE GAS PRIVATE ELECTRICAL MAIN PRESENT IN THIS APPROXIMATE _____ G ____ GAS PL PIPELINE WATER WATER SERVICE — SANITARY SEWER — SANITARY FORCEMAIN FIELD OBSERVED SMALL CONDUIT FIELD VERIFIED AN UNKNOWN CONDUCTIVE ———— ST ———— STORM SEWER ABOVE GROUND IN THIS ALIGNMENT. SIGNAL ALONG THIS ALIGNMENT. UNABLE TO — UNKNOWN CONDUCTIVE SIGNAL DETERMINE OWNERSHIP/TYPE OF PLANT AT ———— QUALITY LEVEL "B" TIME OF INVESTIGATION. IF CRITICAL, —— — QUALITY LEVEL "C" FURTHER INVESTIGATION (TEST HOLES) MAY —---- QUALITY LEVEL "D" BE REQUIRED. POSSIBLE OLD STREET LIGHT. ————LIMIT———— LIMIT OF INVESTIGATION ∠CB1006 117.58 CONTINUES OUT OF LIMITS SE INV 116.04 200 CON (1.54m) FLOW ARROW rWC3001 117.52 FIELD VERIFIED AN UNKNOWN CONDUCTIVE~ END CAP TOP OF PIPE 116.11 (1.41m) PRIVATE ELECTRICAL ENDS AT A BOX SIGNAL ALONG THIS ALIGNMENT. UNABLE TO FIELD VERIFIED AN UNKNOWN CONDUCTIVE BOTTOM OF CHAMBER 115.67 (1.85m) LOCATION BASED ON RECORD INFO SIGNAL ALONG THIS ALIGNMENT. UNABLE TO DETERMINE OWNERSHIP/TYPE OF PLANT AT FIELD OBSERVED CHAMBER FULL OF WATER. FIELD OBSERVED BURNT HYDRO TIME OF INVESTIGATION. IF CRITICAL, DETERMINE OWNERSHIP/TYPE OF PLANT AT LOCATION BASED ON FIELD OBSERVATION CABLES STICKING OUT OF THE FURTHER INVESTIGATION (TEST HOLES) MAY TIME OF INVESTIGATION. IF CRITICAL, _CSTMH1007 117.52 GROUND IN THIS LOCATION. POSSIBLE FURTHER INVESTIGATION (TEST HOLES) MAY BE REQUIRED. POSSÌBLE GAS SERVICE. LOSS OF SIGNAL SITE OF OLD TRANSFORMER. NE INV 115.04 525 CON (2.48m) BE REQUIRED. POSSIBLE WATER SERVICE AS FIELD OBSERVED HYDRO POLE WITH-BLUE PAINT WAS OBSERVED ON FENCE AT SE OBV 114.88 (2.61m) STORM MAINTENANCE HOLE LIGHT AND 2 EMPTY VISIBLE CONDUITS. SW OBV 115.02 600 CÓN (2.47m) THIS LOCATION. UNABLE TO MEASURE SIZE OF SOUTH EAST SANITARY MAINTENANCE HOLE FIELD OBSERVED CONDUIT WITH PIPE DUE TO CHAMBER CONFIGURATION SMALL CABLES STICKING OUT OF THE (PIPE TOO OFFSET). CATCH BASIN GROUND AT THIS LOCATION. WATER CHAMBER √SAMH2002 117.48 -STMH1004 118.31 / NE OBV 114.49 375 CON (2.99m) ✓ENBRIDGE RECORDS INDICATE GAS FIRE HYDRANT NE INV 115.89 600 CON (2.42m) STORM SEWER (QLD)~ SE OBV 114.96 300 CON (2.96m) MAIN ENDS IN THIS APPROXIMATE SW INV 115.92 500 CON (2.39m) LOCATION. SW OBV 114.53 375 CON (2.95m) CONCRETE PANEL FENCE WATER VALVE ELD OBSERVED SOUTH EAST PIPE APPEARS -CB1009A 116.92 GAS VALVE SE INV 115.73 250 CON (1.19m) STORM SEWER (QLD)~ STORM SEWER (QLD)~ SHARED CHAMBER WITH CB1009B UTILITY POLE -CB1009B 116.92 LIGHT STANDARD SHARED CHAMBER WITH CB1009A HAND WELL -SAMH2003 117.14 E OBV 110.52 375 CON (3.62m) HYDRO MAINTENANCE HOLE SW OBV 110.74 375 CON (3.40m) HYDRO VAULT / TRANSFORMER TELECOM PEDESTAL 350 CON ST JOHN STREE FLUSH-TO-GRADE BELL MAINTENANCE HOLE `STMH1010 116.96 ROGERS MAINTENANCE HOLE NE INV 115.34 300 CON (1.62m) STMH1001 119.36-/ SW OBV 115.80 525 CON (1.16m) UNKNOWN MAINTENANCE HOLE NW INV 116.76 300 CON (2.60m) TEST HOLE NE INV 116.6 500 CON (2.76m) \SAMH2001 118.52 CB1005 117.51 W INV 116.88 350 CON (2.48m) ASCE QUALITY LEVELS NE OBV 115.40 375 CON (3.12m) NW INV 115.97 250 CON (1.54m) SW INV 116.99 350 CON (2.37m) SE OBV 115.45 375 CON (3.07m) CB1008A 116.92 THE UTILITY INFORMATION SHOWN ON THIS DRAWING WAS NW OBV 115.90 300 CON (1.02m) COLLECTED IN ACCORDANCE TO ASCE STANDARD 38-22. FIELD VERIFIED AN UNKNOWN CONDUCTIVE CB1003 118.5 SHARED CHAMBER WITH CB1008B THE INFORMATION IS SHOWN BY QUALITY LEVEL WHICH SIGNAL ALONG THIS ALIGNMENT. UNABLE TO SE INV 116.83 250 CON (1.67m) INDICATES THE LEVEL OF EFFORT USED TO DETERMINE DETERMINE OWNERSHIP/TYPE OF PLANT AT └WC3002 ~116.49 CB1008B 116.92 THE LOCATION OF THE DATA TIME OF INVESTIGATION, HOWEVER IT SHARED CHAMBER WITH CB1008A TOP OF PIPE ~114.45 300 MET (2.04m) STORM SEWER (QLD) UNABLE TO OPEN CHAMBER DUE TO ALIGNS WITH BELL RECORDS. IF CRITICAL, QUALITY LEVEL "D" - INFORMATION DERIVED CAR PARKED ON CB. FURTHER INVESTIGATION (TEST HOLES) MAY CB1002 118.51 FROM EXISTING RECORDS OR VERBAL BE REQUIRED. FIELD FIELD FOUND UNKNOWN SIGNAL IN NW INV 116.74 250 CON (1.77m) RECOLLECTIONS. THIS AREA. ALECTRA RECORDS SHOW HYDRO LINE IN THE SAME LOCATION. LINE QUALITY LEVEL "C" - INFORMATION OBTAINED SHOWN AS HYDRO AT QLB ON DRAWING. BY SURVEYING AND PLOTTING VISIBLE ABOVE GROUND UTILITY FEATURES AND BY USING PROFESSIONAL JUDGEMENT IN CORRELATING THIS INFORMATION TO THE QUALITY LEVEL "D" QUALITY LEVEL "B" - INFORMATION OBTAINED THROUGH THE APPLICATION OF APPROPRIATE SURFACE GEOPHYSICAL METHODS TO DETERMINE THE EXISTENCE AND APPROXIMATE HORIZONTAL POSITION OF THE UTILITIES. QUALITY LEVEL "A" - PRECISE HORIZONTAL AND VERTICAL LOCATION OF UTILITES OBTAINED BY THE ACTUAL EXPOSURE AND SUBSEQUENT MEASUREMENT OF SUBSURFACE UTILITIES. PREPARED BY. DISCLAIMER. CLIENT. REVISIONS (MM/DD/YY THIS DRAWING WAS PRODUCED BY 4SIGHT 69 & 117 JOHN STREET HE ENGINEER'S SEAL M. KAZI 01/26/24 DRAWN CROZIER CONSULTING INC FOR THE USE OF THE CLIENT. 4SIGHT INC HEREON IS TO CERTIFY THAT MISSISSAUGA, ON DOES NOT ACCEPT ANY RESPONSIBILITY FOR THE UTILITIES SHOWN HAVE **ENGINEERS** CHECKED A. MCDERMOTT 02/16/24 ANY UNAUTHORIZED USE BY THIRD PARTIES, BEEN INVESTIGATED IN LE ARCAND OR ANY MODIFICATION MADE TO THIS ACCORDANCE WITH STANDARD \PPROVED L. ARCAND 90538158 02/23/24 DRAWING. UE INDUSTRY PRACTICES. DRAWING. ALL OTHER INFORMATION PROJECT NO. 23-0179 SUBSURFACE UTILITY ENGINEERING HEREON HAS BEEN PROVIDED BY OTHERS AND IS NOT A INVESTIGATION PART OF THIS CERTIFICATION. SHEET NO. 01 OF 01 1: 250

Proposed Plant Material List

Refer to L2-01

KEY	QNTY	BOTANICAL NAME	COMMON NAME	HT/CAL	SPREAD	ROOT	DROUGHT TOLERANT	NATIVE	REMARKS
DECIDUO	US TREE	S							
ARS		Acer rubrum 'Autumn Spire'	Autumn Spire Maple	70 mm		B.&B.	High	Yes	Full Form
AXF		Acer x freemanii 'Jeffersred'	Jeffersred Freeman Maple	70 mm		B.&B.	High	Hybrid	Full Form
GSS		Gleditsia triacanthos var. inermis 'Draves'	Street Keeper Honey-Locust (Clump)	60 mm		B.&B.	High	Cultivar	Tree Form Multi Stem
PCC		Pyrus calleryana 'Chantecleer'	Chanticleer Pear	70 mm		B.&B.	High	No	Full Form
QRB		Quercus rubra	Red Oak	70 mm		B.&B.	Med.	Yes	Full Form
TAB		Tilia Americana 'Redmond'	Redmond Basswood	70 mm		B.&B.	High	Yes	Full Form
SPECIME	N MULTIS	STEM DECIDUOUS SHRUBS							
ACB		Amelancier canadensis 'Ballerina'	Ballerina Serviceberry	200 cm		B.&B.	High	Yes	Multi Stem
CCA		Cercls canadensis 'Multi Stem'	Eastern Red Bud	180 cm	pink/pur	B.&B.	High	Yes	Multi Stem
CAL		Cornus alternifolia	Pagoda Dogwood	150 cm		B.&B.	High	Yes	Multi Stem
GRASSES	3			·					
CAC		Calamagrostis acutiflora 'Karl Foerster'	Karl Foerster Feather Reed Grass			5 Gal.	High	No	Full Form
DEC		Deschampia cespitosa	Tufted Hairgrass			2 Gal.	High	Yes	Full Form
PAL		Pennisetum alopecuroides 'Hameln'	Hameln Dwarf Fountain Grass			2 Gal.	High	No	Full Form

KEY	QNTY	BOTANICAL NAME	COMMON NAME	HT/CAL	SPREAD	ROOT	DROUGHT TOLERANT	NATIVE	REMARKS
CONIFER	OUS SHR	UBS	·						
JCG		Juniperus chinensis 'Gold Coast'	Gold Coast Juniper	50 cm		C.G.	Med.	No	Full Form
TCF		Taxus x media 'Fairview'	Fairview Yew		65 cm	C.G.	Med.	No	Full Form
DECIDUC	US SHRU	IBS	·	·					
CNS		Cornus sericea	Red Osier Dogwood	80 cm		C.G.	High	Yes	Full Form
HPB		Hydrangea paniculata 'Bombshell'	Dwarf Bombshell Hydrangea	60 cm		5 gal.	High	No	Full Form
POD		Physocarpus opulifolius 'Diablo'	Diablo Purpleleaf Ninebark	80 cm		C.G.	High	Yes	Full Form
RHG		Rhus aromatica 'Gro-Low'	'Gro-Low' Fragrant Sumac	60 cm		C.G.	High	Yes	Full Form
SJL		Spirea japonica 'Little Princess'	Dwarf Red Spirea	60 cm		C.G.	High	No	Full Form
SMP		Syringa meyeri 'Palibin'	Purple Dwarf Korean Lilac	60 cm		C.G.	High	No	Full Form
PERENNI	ALS		•	•					
GER		Geranium 'Rozanne'	Hardy Cranesbill Geranium			2 Gal.	High	Yes	Full Form
ECH		Echinacea purpurea	Purple Cone Flower			2 Gal.	High	Yes	Full Form
HSD		Hemerocallis 'Stella D'oro'	Stella D'oro (Yellow) Daylilies			2 Gal.	High	No	Full Form
PLS		Perovskia atriplicifolia 'Little Spire'	Little Spire Russian Sage			2 Gal.	High	No	Full Form
RUD		Rudbeckia fulgida var. sullivantii 'Goldsturm'	Black Eyed Susan			2 Gal.	High	Cultivar	Full Form





Architect:

TREGEBOV COGAN ARCHITECTURE

40 St. Clair Avenue East, Suite 303 Toronto, ON M4T 1M9 office@tcarchitecture.ca 647-352-3350

Client/Owner:

Reference Key

Legend

Refer to L2-02

NOTE: THE LANDSCAPE MASTER PLAN IS

SITE PLAN. THEREFORE, SOME OF THE


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LANDSCAPE FEATURES MAY BE HIDDEN ON

THIS PLAN. PLEASE REFER TO THE FLOOR

PLAN ENLARGEMENTS FOR THESE AREAS

AND THE ACCOMPANYING LABELS.

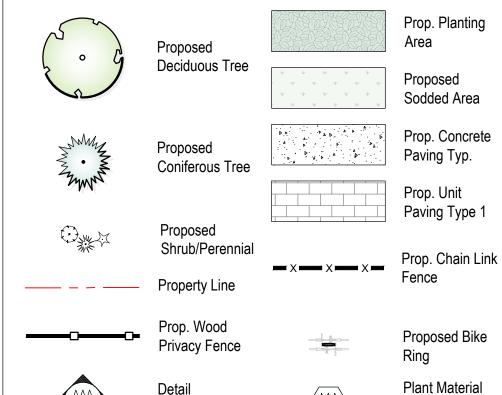

Owner's Note

WE AGREE TO IMPLEMENT THE APPROVED SITE AND LANDSCAPE PLANS WITHIN 18 MONTHS AFTER THE EXECUTION OF THE SITE PLAN UNDERTAKING AND WILL RETAIN THE LANDSCAPE ARCHITECT TO MAKE PERIODIC SITE INSPECTIONS. UPON COMPLETION OF THE WORKS WE WILL FORWARD TO THE CITY OF MISSISSAUGA A COPY OF THE COMPLETION NOTIFICATION CERTIFICATE FROM THE LANDSCAPE

ANY REVISIONS TO THE SITE AND LANDSCAPE PLANS WILL BE SUBMITTED TO THE PLANNING AND BUILDING DEPARTMENT, CITY OF MISSISSAUGA FOR REVIEW AND APPROVAL, PRIOR TO

WE HEREBY AUTHORIZE THE CITY, ITS AUTHORIZED AGENTS, SERVANTS, OR EMPLOYEES TO ENTER UPON OUR LAND TO CARRY OUT INSPECTIONS FROM TIME TO TIME AND AGREE TO INDEMNIFY THE CITY AND ITS AUTHORIZED AGENTS AND SAVE THEM HARMLESS FROM ANY AND ALL ACTIONS ARISING OUT OF THE EXERCISE BY THE CITY, ITS AUTHORISED AGENTS, SERVANTS OR EMPLOYEES OF THE RIGHTS HEREBY GIVEN TO THEM. WE UNDERTAKE TO NOTIFY THE CITY

FORTHWITH OF ANY CHANGE (OF OWNERSHIP OF THE SAID LANDS.
Signature of Owner	
Name of Owner	
Address	
- · · ·	.41

The applicant is responsible for ensuring that tree protection hoarding is maintained throughout all phases of demolition and construction in the location and condition as approved by the Planning and Building Department. No materials (building materials, soil, etc.) May be stockpiled within the area of hoarding. Failure to maintain the hoarding as originally approved or the storage of materials within the hoarding will be cause for the tree preservation Letter of

Owner's Signature:

Sign By-Law

INFORMATION PURPOSES ONLY. ALL SIGNS WILL BE SUBJECT TO THE PROVISIONS OF SIGN BY-LAW 0054-2002, AS AMENDED AND A SEPERATE SIGN APPLICATION WILL BE REQUIRED THROUGH THE BUILDING DIVISION.

Grading	Note
Grading	11010

I HEREBY CERTIFY THAT THIS LANDSCAPE PLAN CONFORMS TO THE SITE GRADING AND DRAINAGE PLAN (BY OTHERS) FOR THIS APPLICATION

Signature of Landscape Architect:



11 Issued for ZBA Sub 3 08/20/24 08/20/24 10 Issued for Review 04/26/24 09 Issued for ZBA Sub 03/20/24 08 Issued for Coordination 02/22/24 07 Issued for Coordination 02/06/24 Revised per New Site Plan Issued for Resubmission Issued for Coordination Issued for ZBA Submission 02 Rev. per New Site Plan 06/19/23 04/24/23 01 Issued for Coordination No. Revision Date



Drawing Title:

Proposed Residential Development 69 & 117 John Street

Mississauga, Ontario **1:400** Date: **April 2023**


D.R. Checked By: **L.M.** Drawn By:

Landscape **Master Plan**

Project No. L1-01

ARCHITECT AND THE APPLICABLE INSPECTION FEE. COMMENCEMENT OF THE WORKS. **Existing Tree Preservation** Credit to be held for two (2) years following completion of all site works. SIGNAGE SHOWN ON THE SITE DEVELOPMENT PLANS IS FOR

CONNECTION-TO SECOND LEVEL LANDSCAPE DECK NATURAL STONE
STEPS WITHIN SLOPED
PLANTING AREA TYP. WOOD PRIVACY— FENCE ALONG PROPERTY LINE DOUBLE GATE FOR TENCED IN DOG RUN AREA BENCH SEATING PRIVATE PATIOS — WITH 1800mm HT WOOD PRIVACY PARKLAND DEDICATION ARÉA -FEATURE PAVING ا ۱۱۱۱ اس BENCH SEATING BIKE PARKING (8 - RINGS TO PROVIDE (13 RINGS TO PROVIDE 26

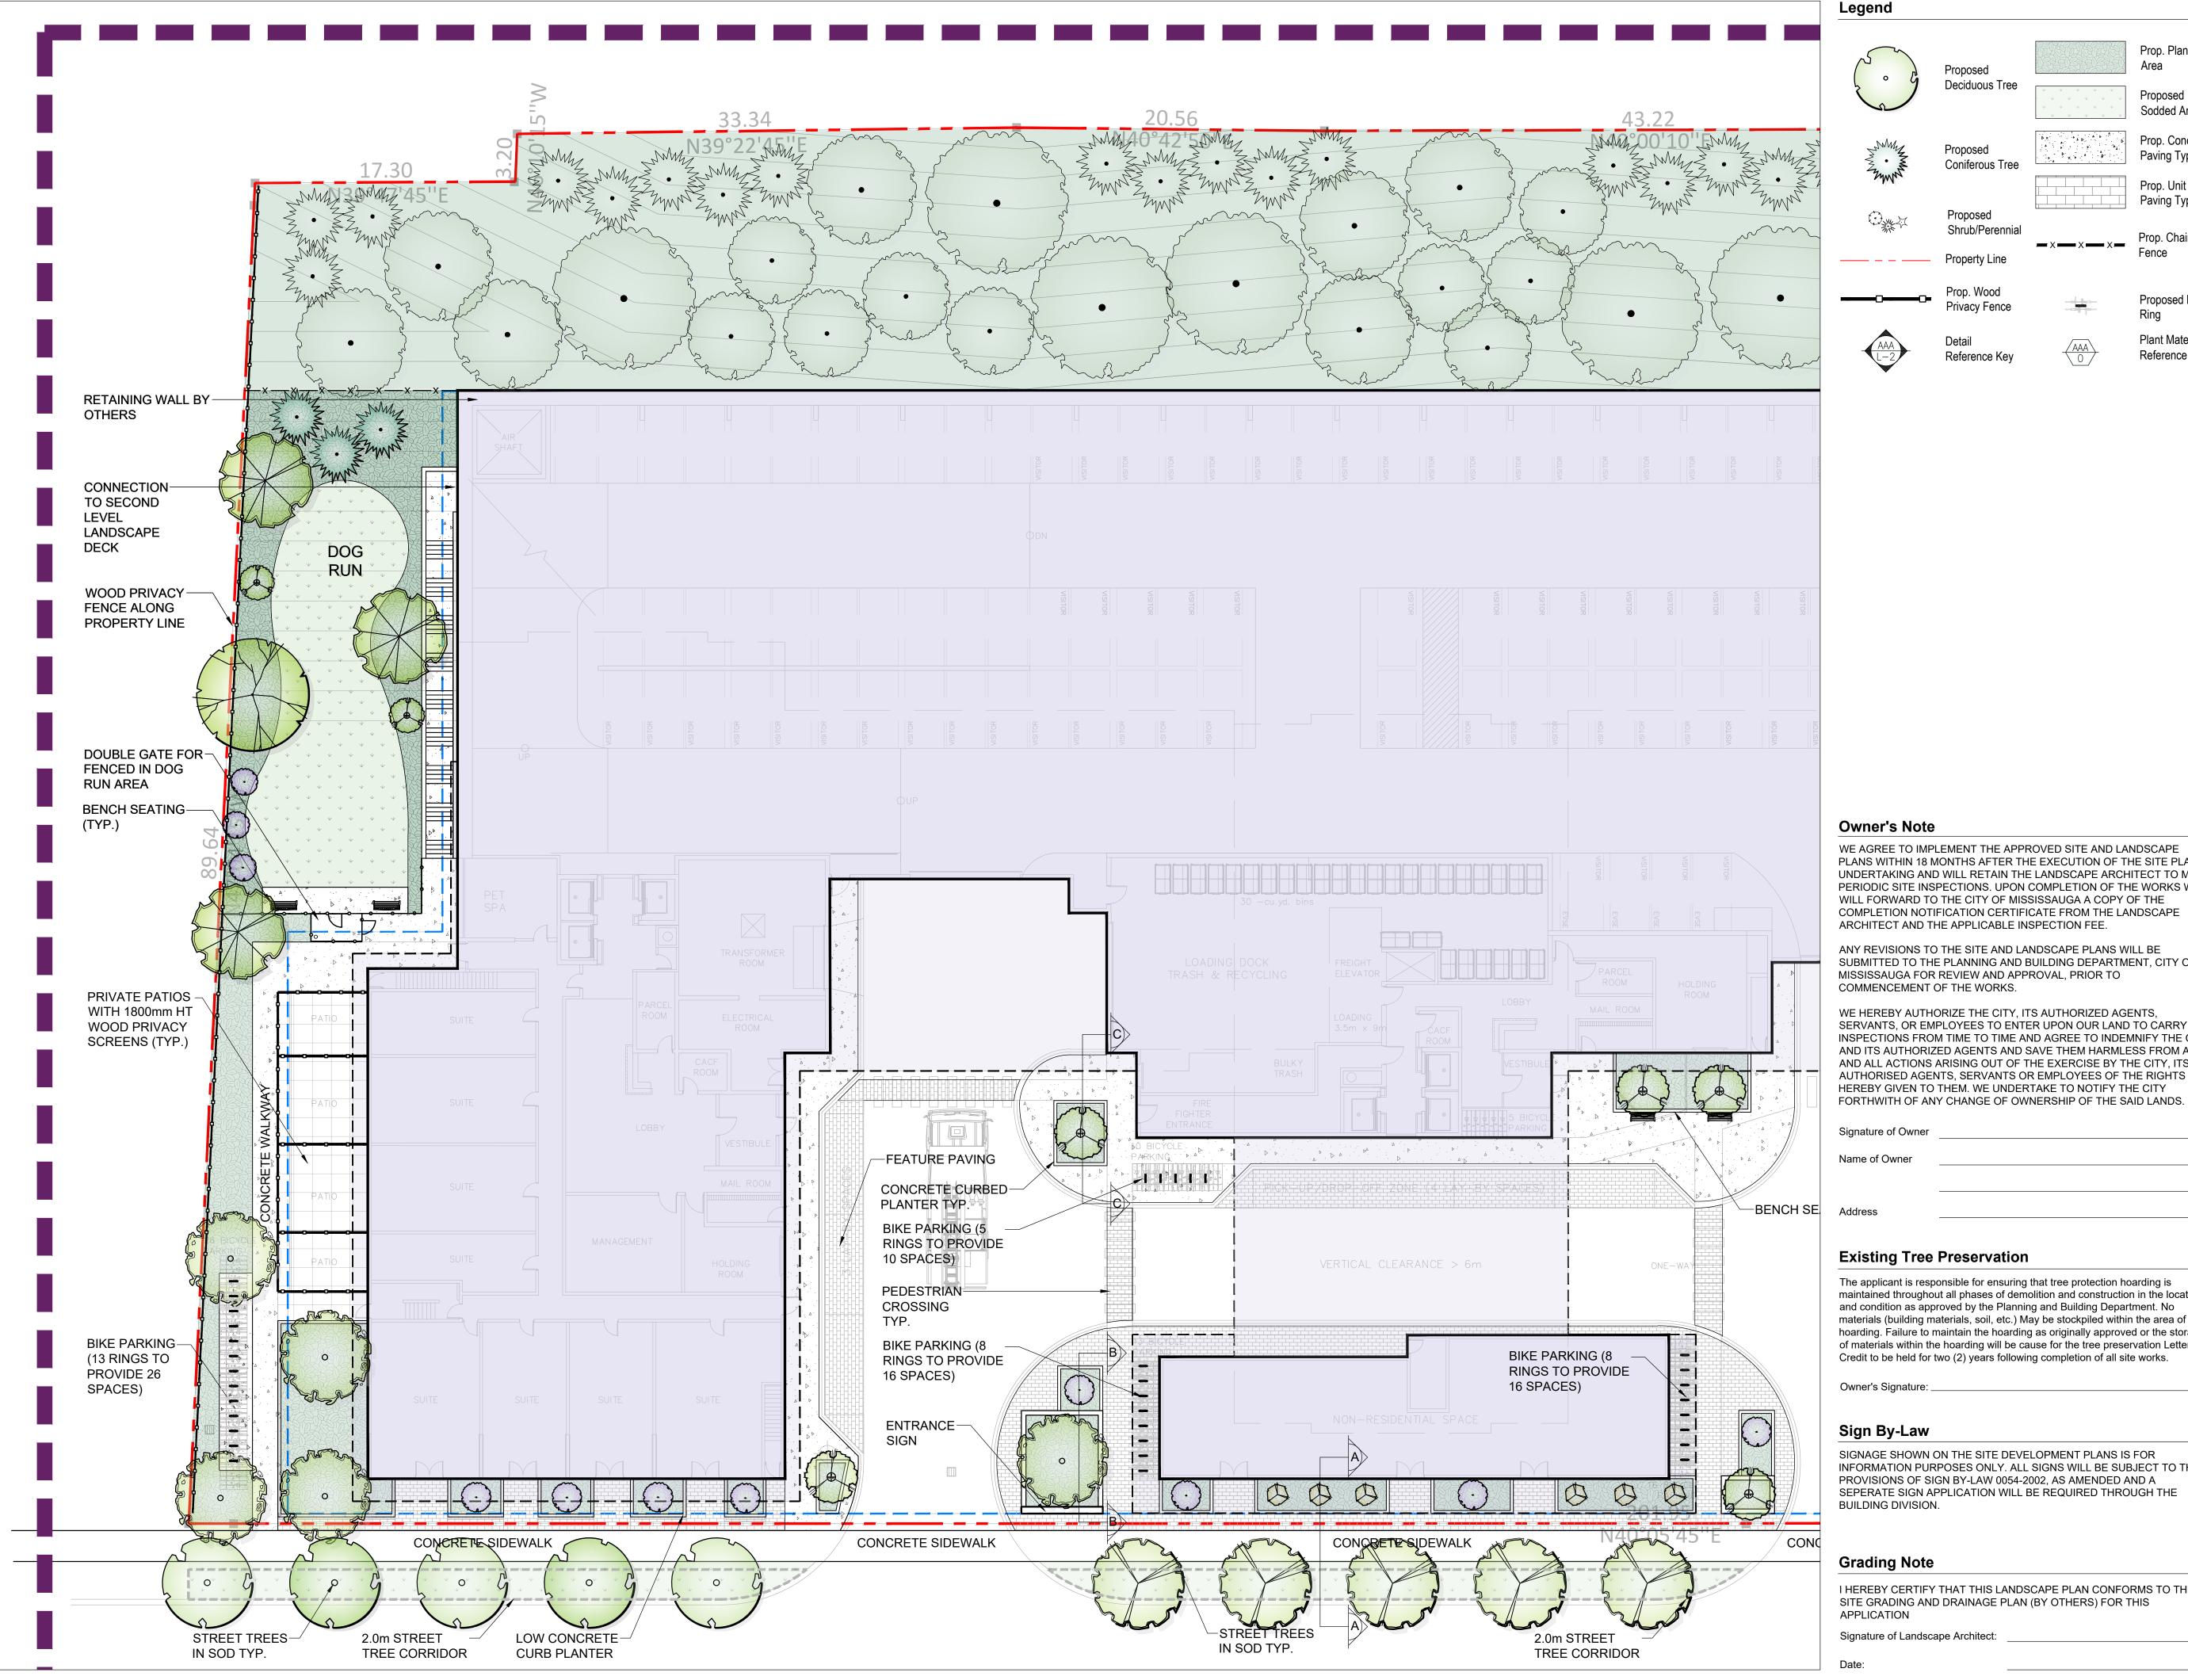



MARTON SMITH LANDSCAPE ARCHITECTS 170 The Donway W Suite 206.

Toronto, Ontario, Canada. M3C 2G3

tel. 416.492.9966 | email. info@msla.ca

Proposed Sodded Area

Prop. Concrete

Prop. Chain Link

Plant Material Reference Key

Paving Typ.

Prop. Unit Paving Type 1

TREGEBOV COGAN ARCHITECTURE

40 St. Clair Avenue East, Suite 303 Toronto, ON M4T 1M9 office@tcarchitecture.ca 647-352-3350

Client/Owner:

Municipality **MISSISSAUGA**

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08	Issued for Coordination	03/20/2
07	Issued for Coordination	02/22/2
06	Revised per New Site Plan	02/06/2
05	Issued for Resubmission	09/13/2
04	Issued for Coordination	08/17/2
03	Issued for ZBA Submission	06/27/2
02	Rev. per New Site Plan	06/19/2
01	Issued for Coordination	04/24/2
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09/23/24

08/20/24

04/26/24

11 Issued for ZBA Sub 3

09 Issued for Resubmission

10 Issued for Review

Proposed Residential

69 & 117 John Street


Mississauga, Ontario

1:200 Date: **April 2023 D.R.** Checked By: **L.M.** Drawn By:

Drawing Title:

Ground Floor Enlargement 'A'

L2-01

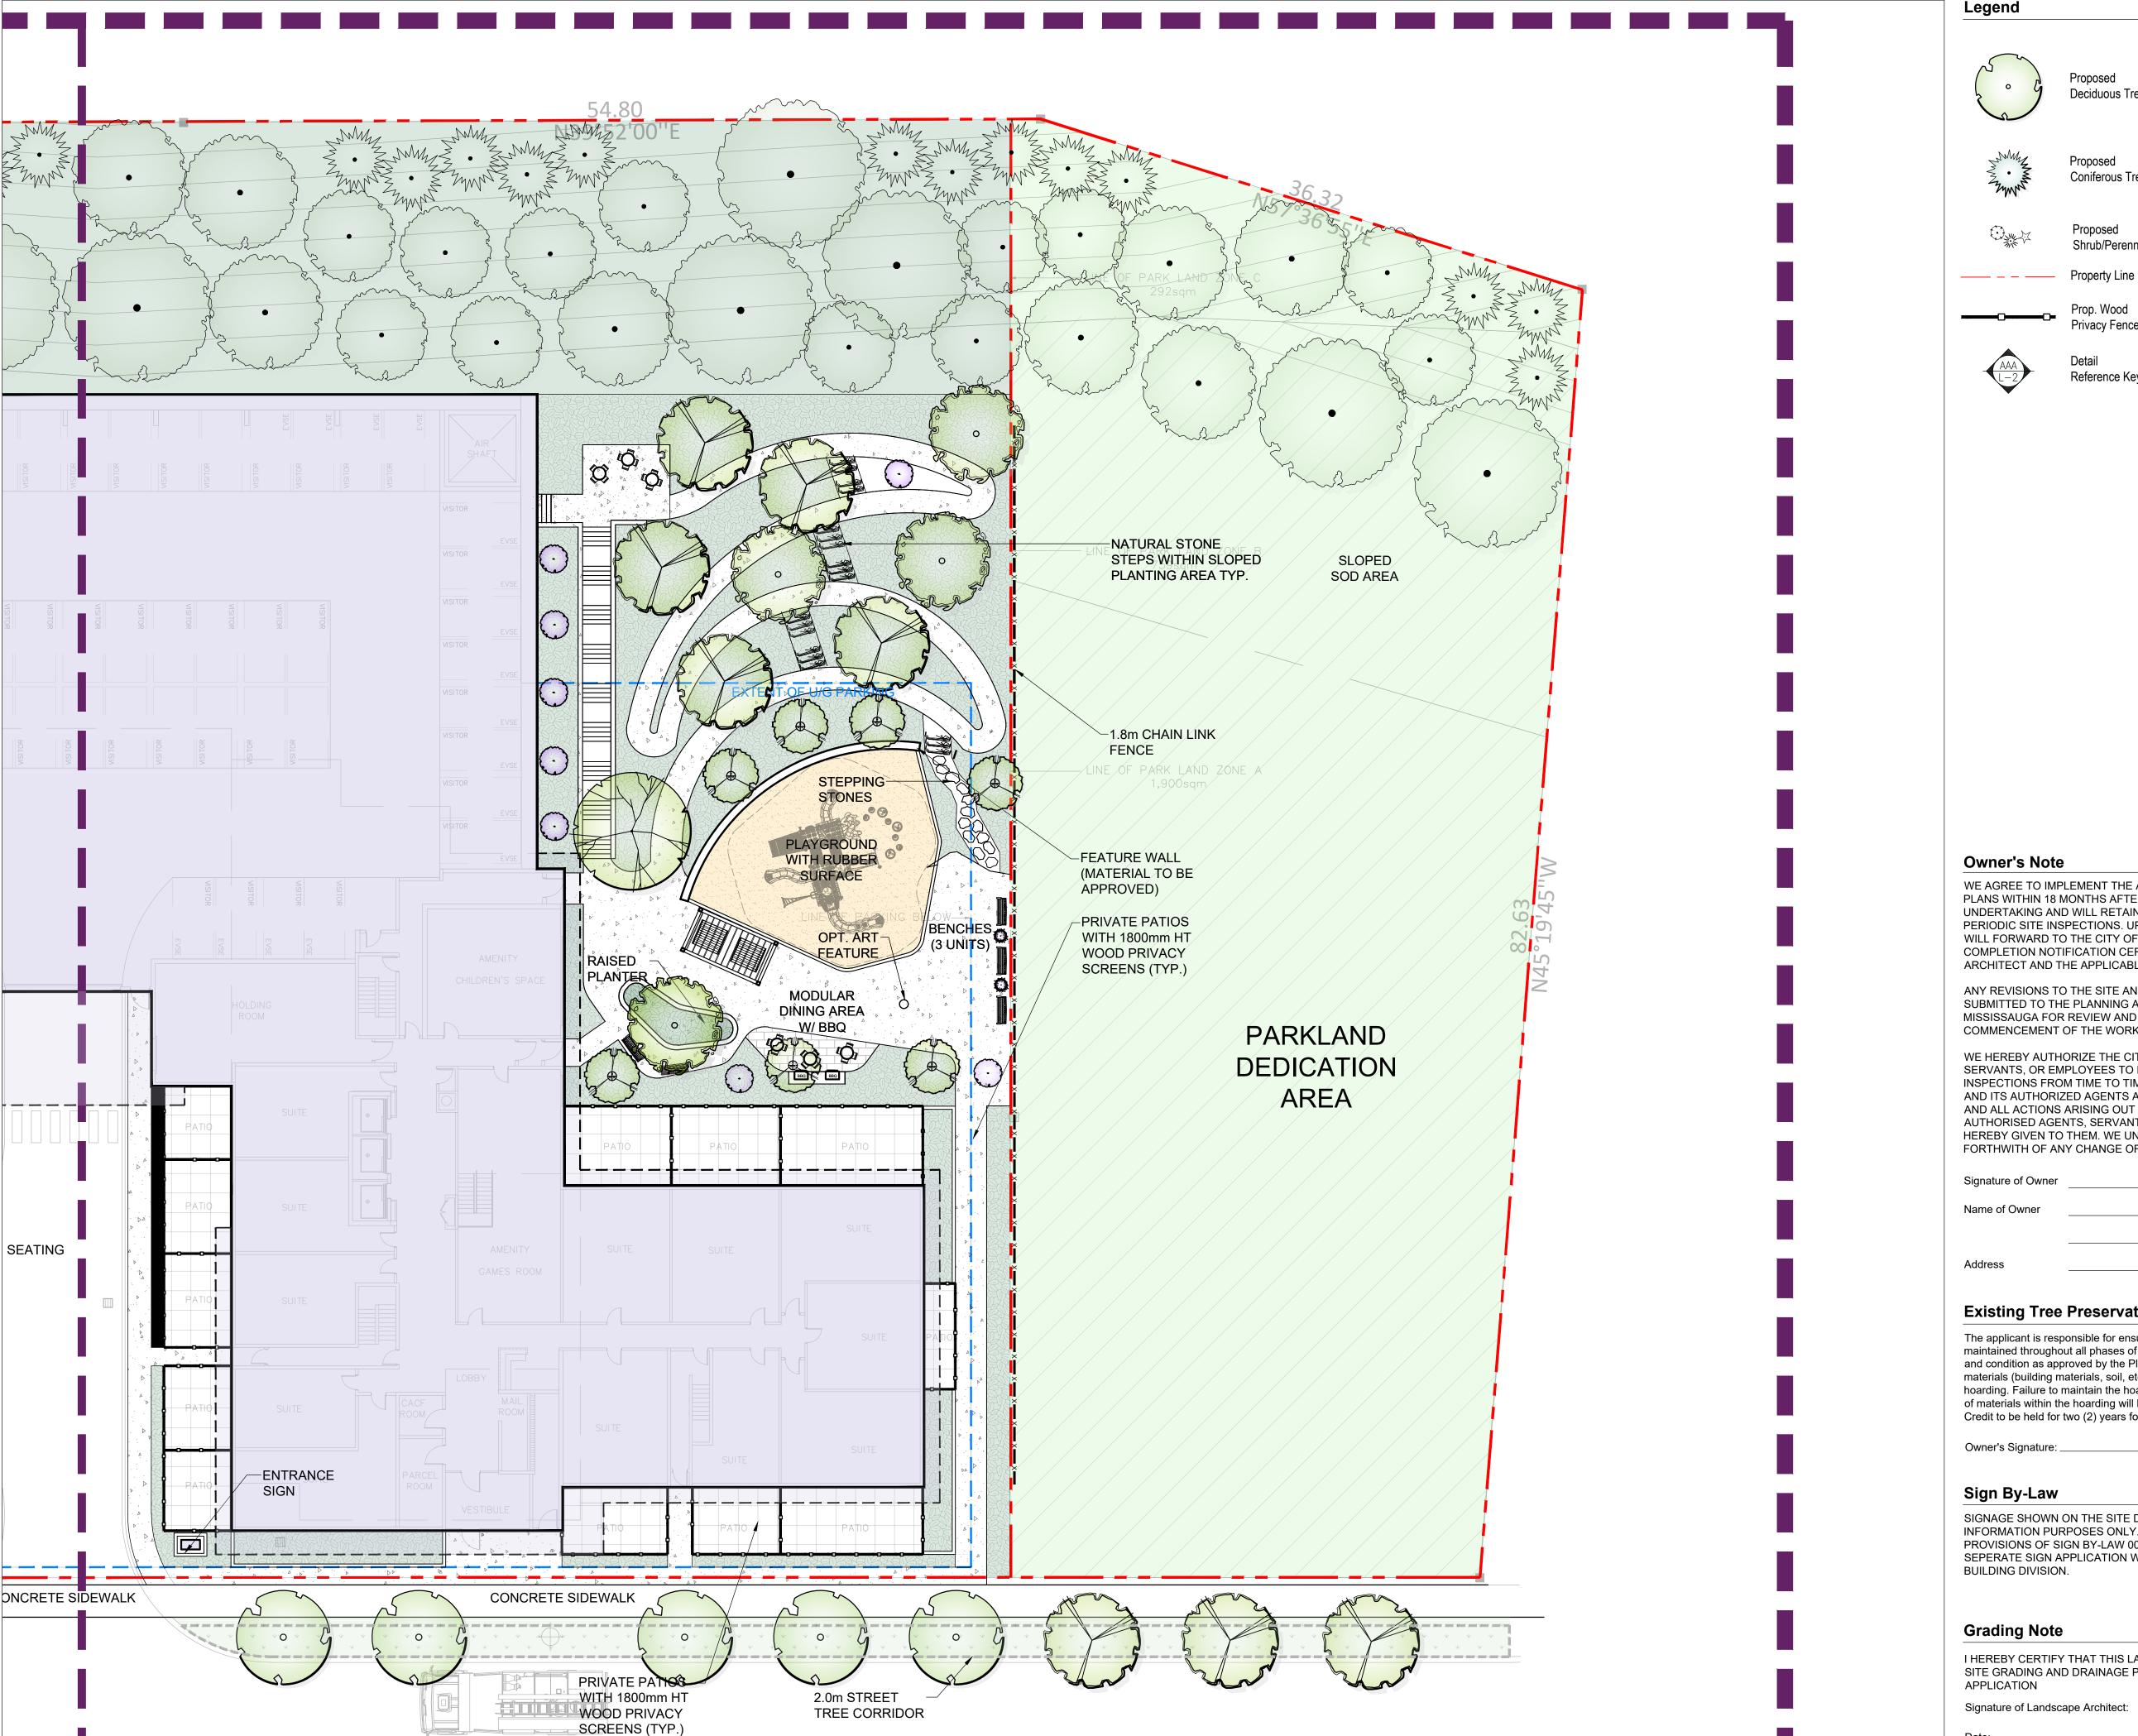



Proposed Sodded Area

Prop. Concrete

Paving Type 1

Plant Material Reference Key

Paving Typ.

MARTON SMITH LANDSCAPE ARCHITECTS

170 The Donway W Suite 206. Toronto, Ontario, Canada. M3C 2G3 tel. 416.492.9966 | email. info@msla.ca

TREGEBOV COGAN ARCHITECTURE

40 St. Clair Avenue East, Suite 303 Toronto, ON M4T 1M9 office@tcarchitecture.ca 647-352-3350

Client/Owner:



Owner's Note

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Deciduous Tree

Coniferous Tree

Shrub/Perennial

Proposed

Prop. Wood

Reference Key

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Sign By-Law

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Grading Note

I HEREBY CERTIFY THAT THIS LANDSCAPE PLAN CONFORMS TO THE SITE GRADING AND DRAINAGE PLAN (BY OTHERS) FOR THIS APPLICATION

Signature of Landscape Architect:

11 Issued for ZBA Sub 3 09/23/24 10 Issued for Review 04/26/24 09 Issued for Resubmission 08 Issued for Coordination 03/20/24 02/22/24 07 Issued for Coordination 06 Revised per New Site Plan Issued for Resubmission Issued for Coordination Issued for ZBA Submission Rev. per New Site Plan 06/19/23 01 Issued for Coordination No. Revision Date

North:



Proposed Residential Development

69 & 117 John Street Mississauga, Ontario

1:200 Date: **April 2023 D.R.** Checked By: **L.M.** Drawn By:

Drawing Title:

Ground Floor Enlargement 'B'

L2-01

Owner's Note

WE AGREE TO IMPLEMENT THE APPROVED SITE AND LANDSCAPE PLANS WITHIN 18 MONTHS AFTER THE EXECUTION OF THE SITE PLAN UNDERTAKING AND WILL RETAIN THE LANDSCAPE ARCHITECT TO MAKE PERIODIC SITE INSPECTIONS. UPON COMPLETION OF THE WORKS WE WILL FORWARD TO THE CITY OF MISSISSAUGA A COPY OF THE COMPLETION NOTIFICATION CERTIFICATE FROM THE LANDSCAPE ARCHITECT AND THE APPLICABLE INSPECTION FEE.

ANY REVISIONS TO THE SITE AND LANDSCAPE PLANS WILL BE SUBMITTED TO THE PLANNING AND BUILDING DEPARTMENT, CITY OF MISSISSAUGA FOR REVIEW AND APPROVAL, PRIOR TO COMMENCEMENT OF THE WORKS.

WE HEREBY AUTHORIZE THE CITY, ITS AUTHORIZED AGENTS, SERVANTS, OR EMPLOYEES TO ENTER UPON OUR LAND TO CARRY OUT INSPECTIONS FROM TIME TO TIME AND AGREE TO INDEMNIFY THE CITY AND ITS AUTHORIZED AGENTS AND SAVE THEM HARMLESS FROM ANY AND ALL ACTIONS ARISING OUT OF THE EXERCISE BY THE CITY, ITS AUTHORISED AGENTS, SERVANTS OR EMPLOYEES OF THE RIGHTS HEREBY GIVEN TO THEM. WE UNDERTAKE TO NOTIFY THE CITY FORTHWITH OF ANY CHANGE OF OWNERSHIP OF THE SAID LANDS.

Signature of Owner	
Name of Owner	
Address	

Existing Tree Preservation

The applicant is responsible for ensuring that tree protection hoarding is maintained throughout all phases of demolition and construction in the location and condition as approved by the Planning and Building Department. No materials (building materials, soil, etc.) May be stockpiled within the area of hoarding. Failure to maintain the hoarding as originally approved or the storage of materials within the hoarding will be cause for the tree preservation Letter of Credit to be held for two (2) years following completion of all site works.

Owner's Signature: ___

Sign By-Law


SIGNAGE SHOWN ON THE SITE DEVELOPMENT PLANS IS FOR INFORMATION PURPOSES ONLY. ALL SIGNS WILL BE SUBJECT TO THE PROVISIONS OF SIGN BY-LAW 0054-2002, AS AMENDED AND A SEPERATE SIGN APPLICATION WILL BE REQUIRED THROUGH THE BUILDING DIVISION.

Grading Note


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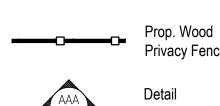
Signature of Landscape Architect:

Legend




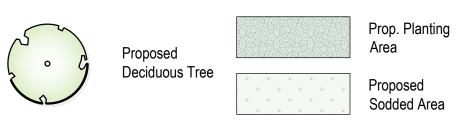




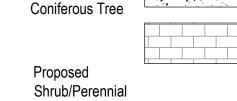

—— — Property Line

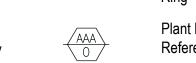

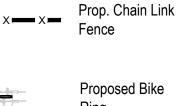


Prop. Concrete

Paving Type 1

Paving Typ.

Prop. Unit

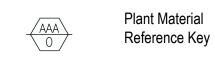




170 The Donway W Suite 206. Toronto, Ontario, Canada. M3C 2G3 tel. 416.492.9966 | email. info@msla.ca


Architect:

TREGEBOV COGAN ARCHITECTURE

40 St. Clair Avenue East, Suite 303 Toronto, ON M4T 1M9 office@tcarchitecture.ca 647-352-3350

Client/Owner:

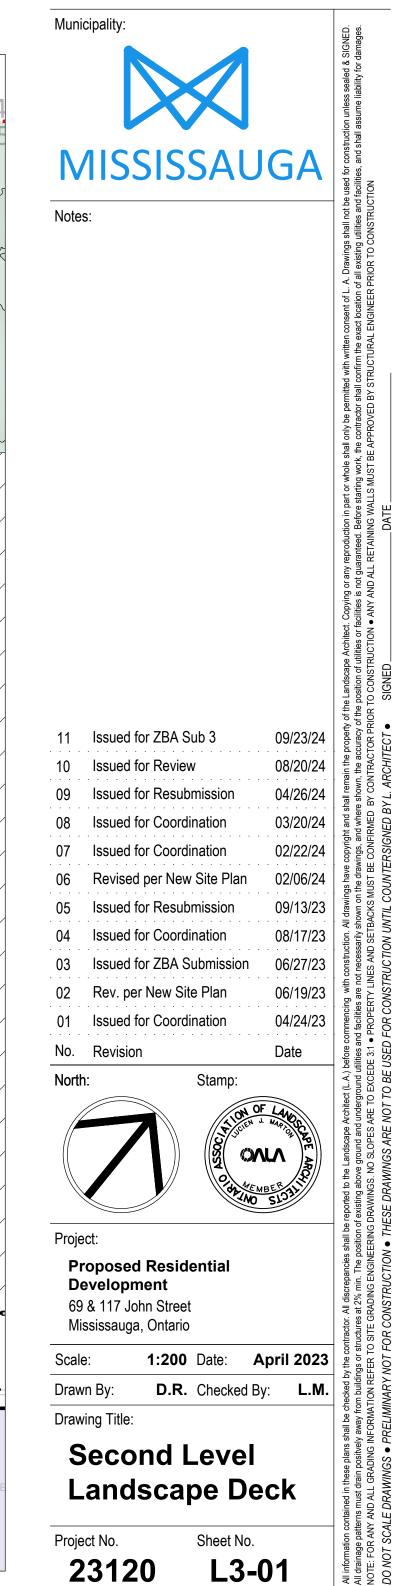

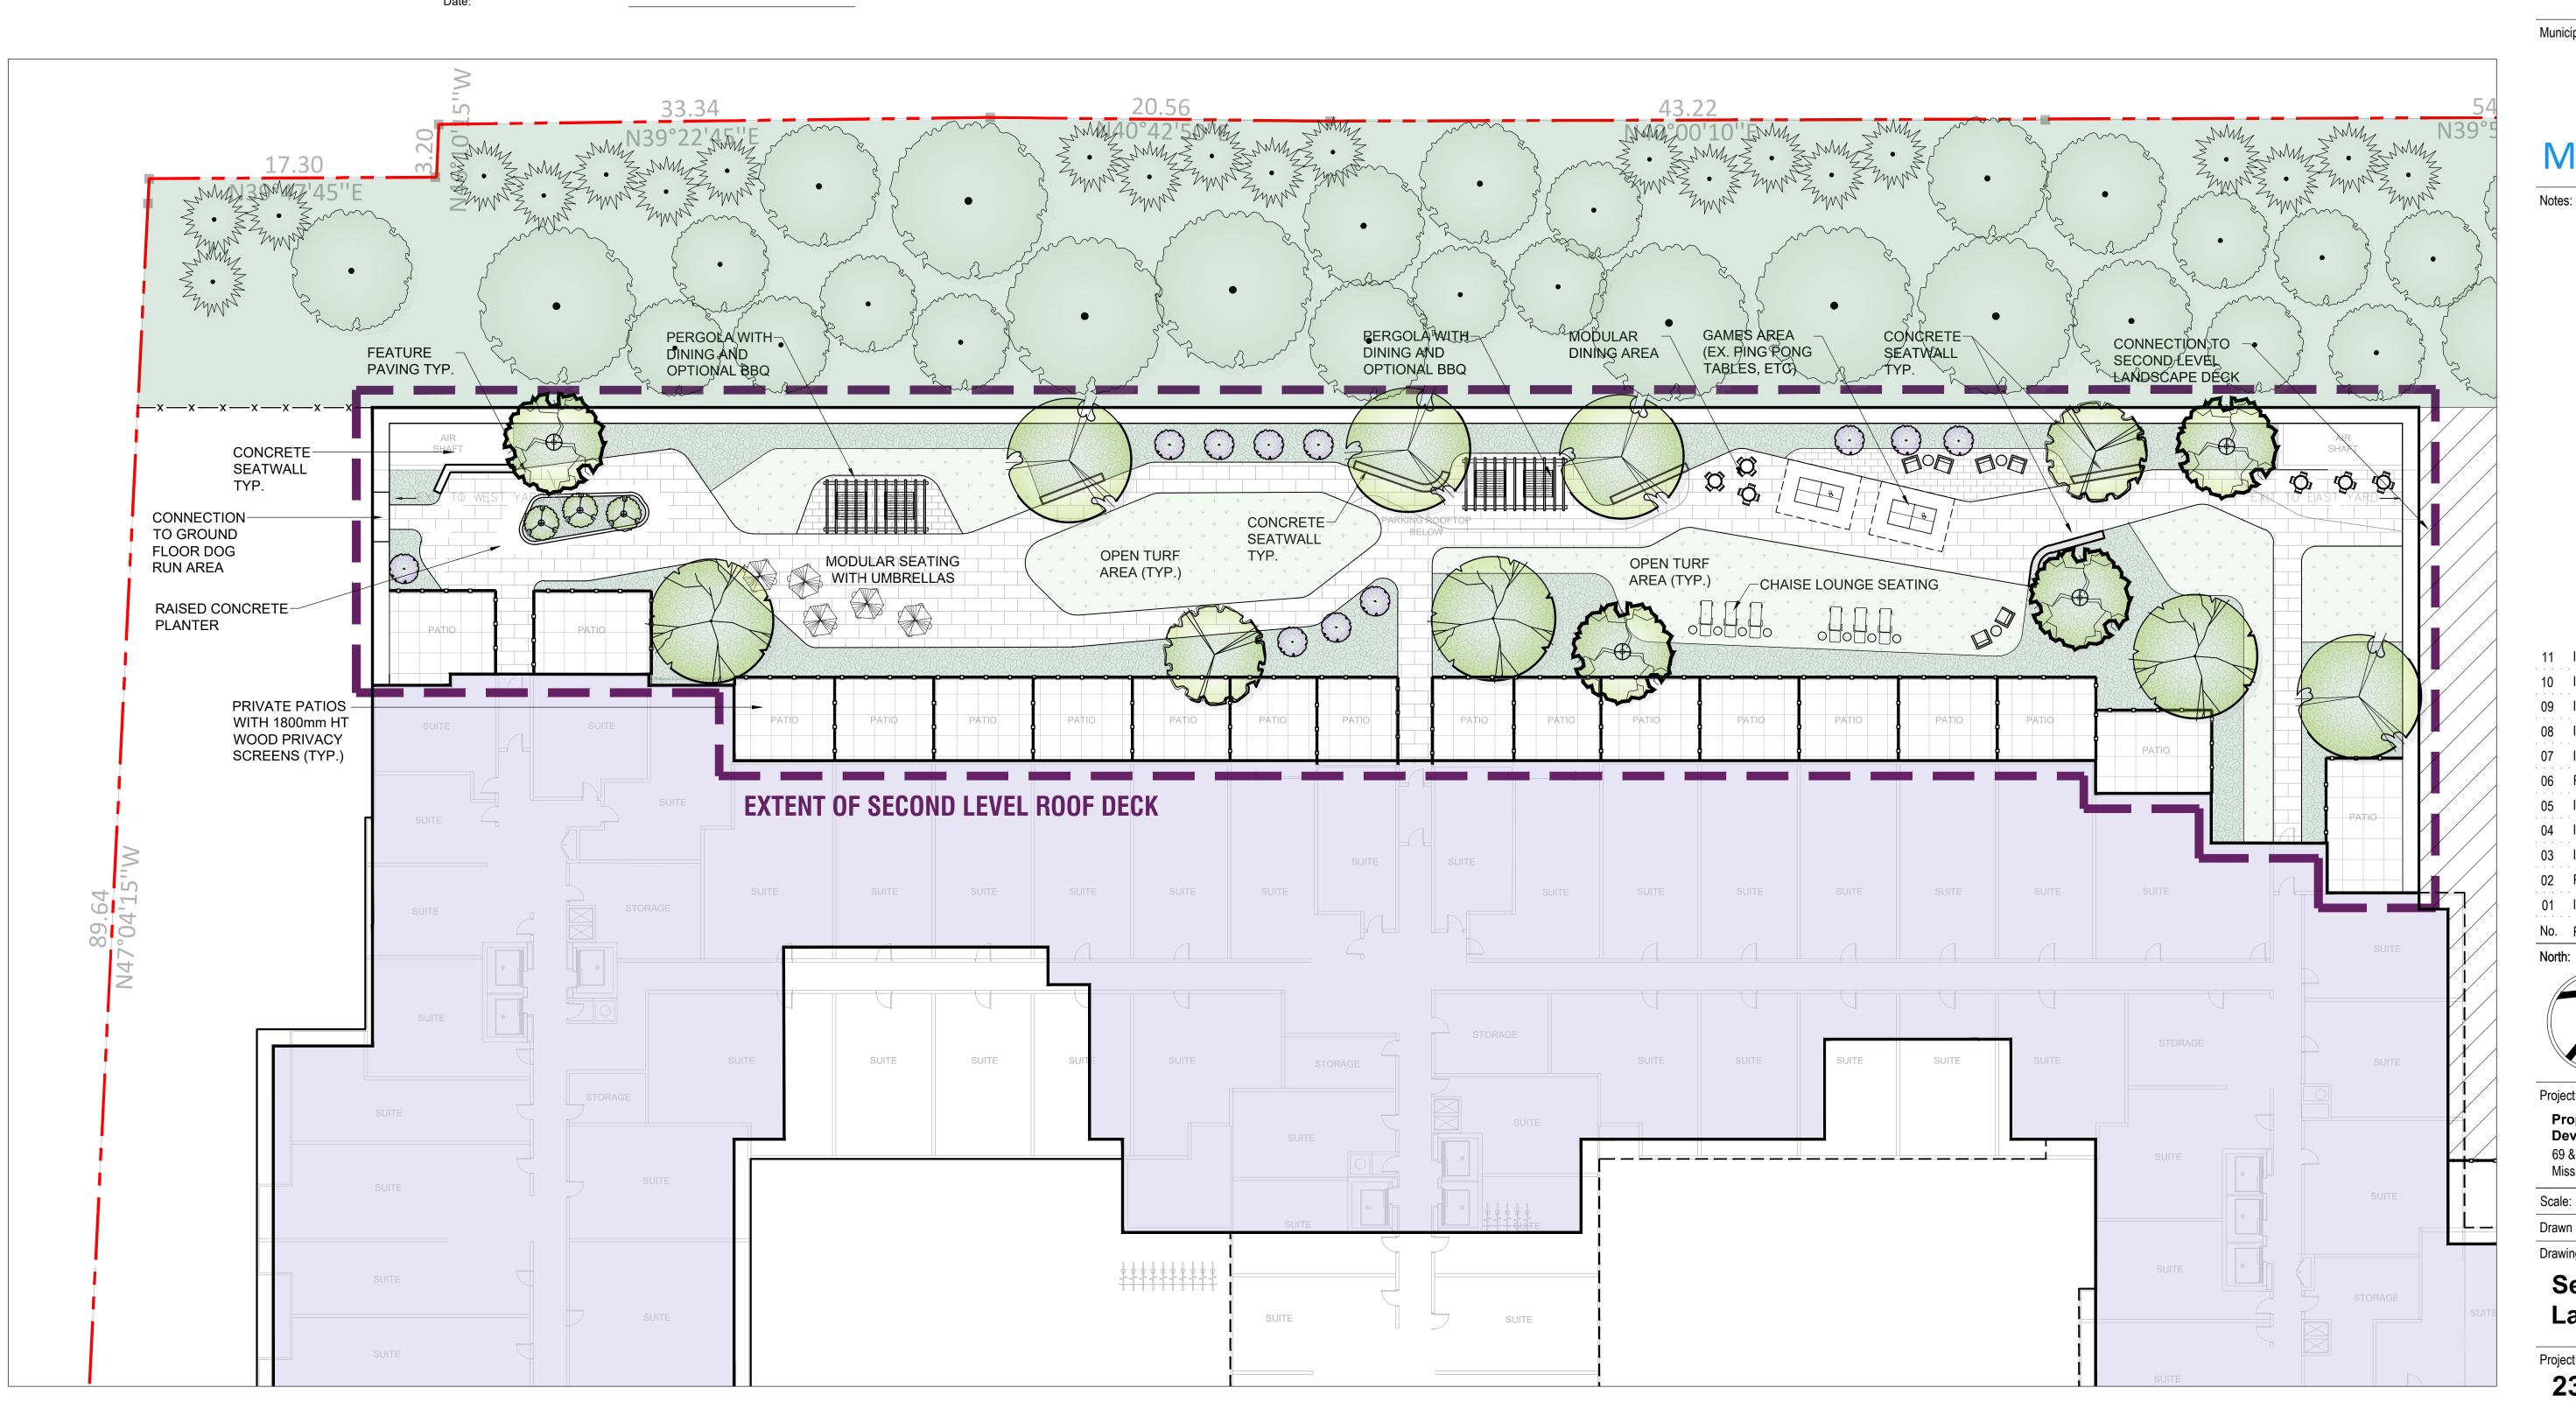

Owner's Note

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Name of Owner	
Address	

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Sign By-Law

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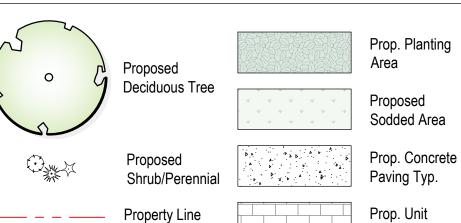
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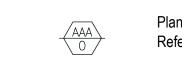
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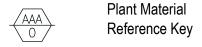
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Signature of Landscape Architect:

Legend








Paving Type 2

Proposed Bike

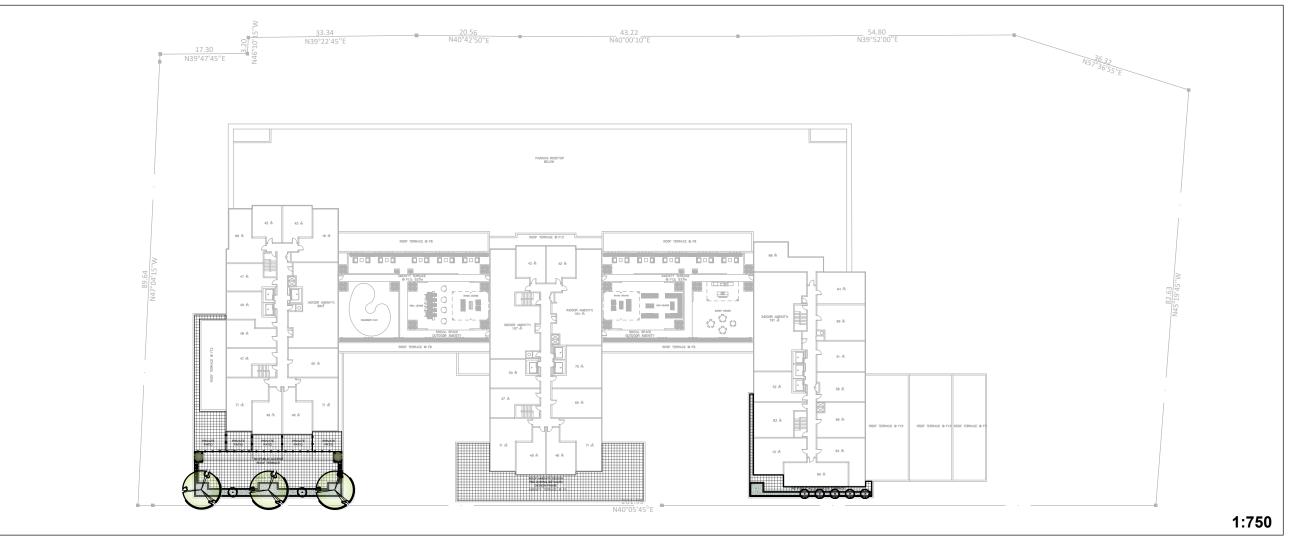

1:150



170 The Donway W Suite 206. Toronto, Ontario, Canada. M3C 2G3 tel. 416.492.9966 | email. info@msla.ca

Architect:

TREGEBOV COGAN ARCHITECTURE

40 St. Clair Avenue East, Suite 303 Toronto, ON M4T 1M9 office@tcarchitecture.ca 647-352-3350

Client/Owner:





08/20/24 04/26/24 09 Issued for Resubmission 03/20/24 Issued for Coordination 07 Issued for Coordination 02/22/24 Revised per New Site Plan Issued for Resubmission Issued for Coordination 03 Issued for ZBA Submission 06/19/23 02 Rev. per New Site Plan 01 Issued for Coordination 04/24/23

No. Revision



1:150


Proposed Residential 69 & 117 John Street Mississauga, Ontario


Scale: As Shown Date: April 2023

D.R. Checked By: **L.M.** Drawn By: Drawing Title:

F4 & F13 Roof **Amenity Concepts**

L4-01

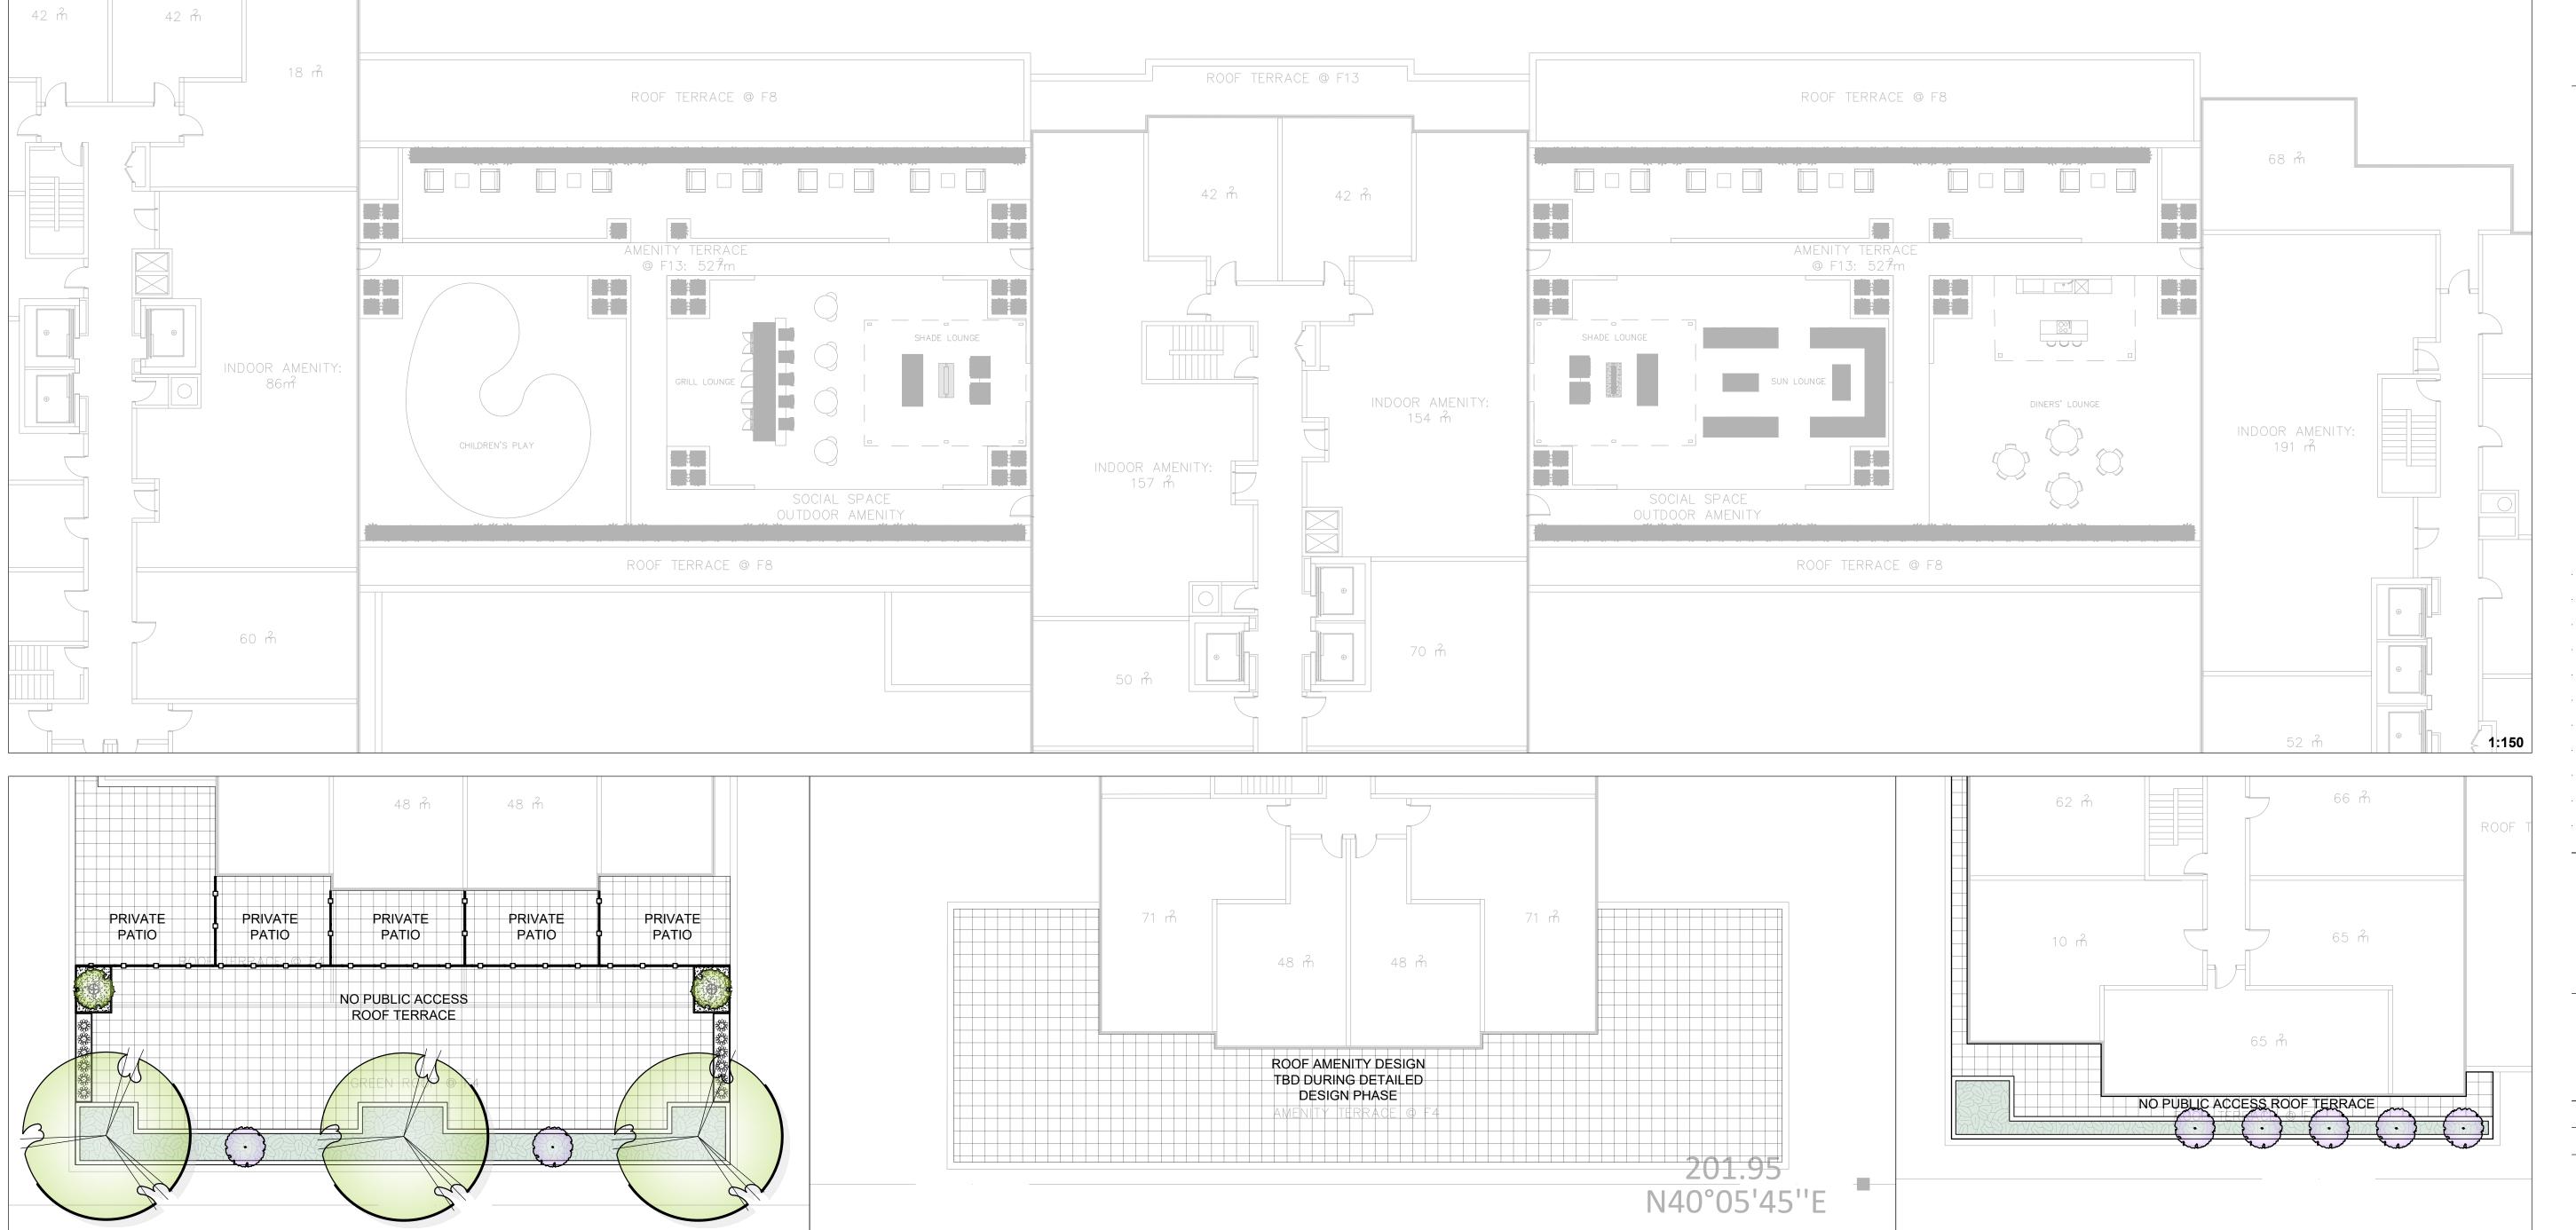

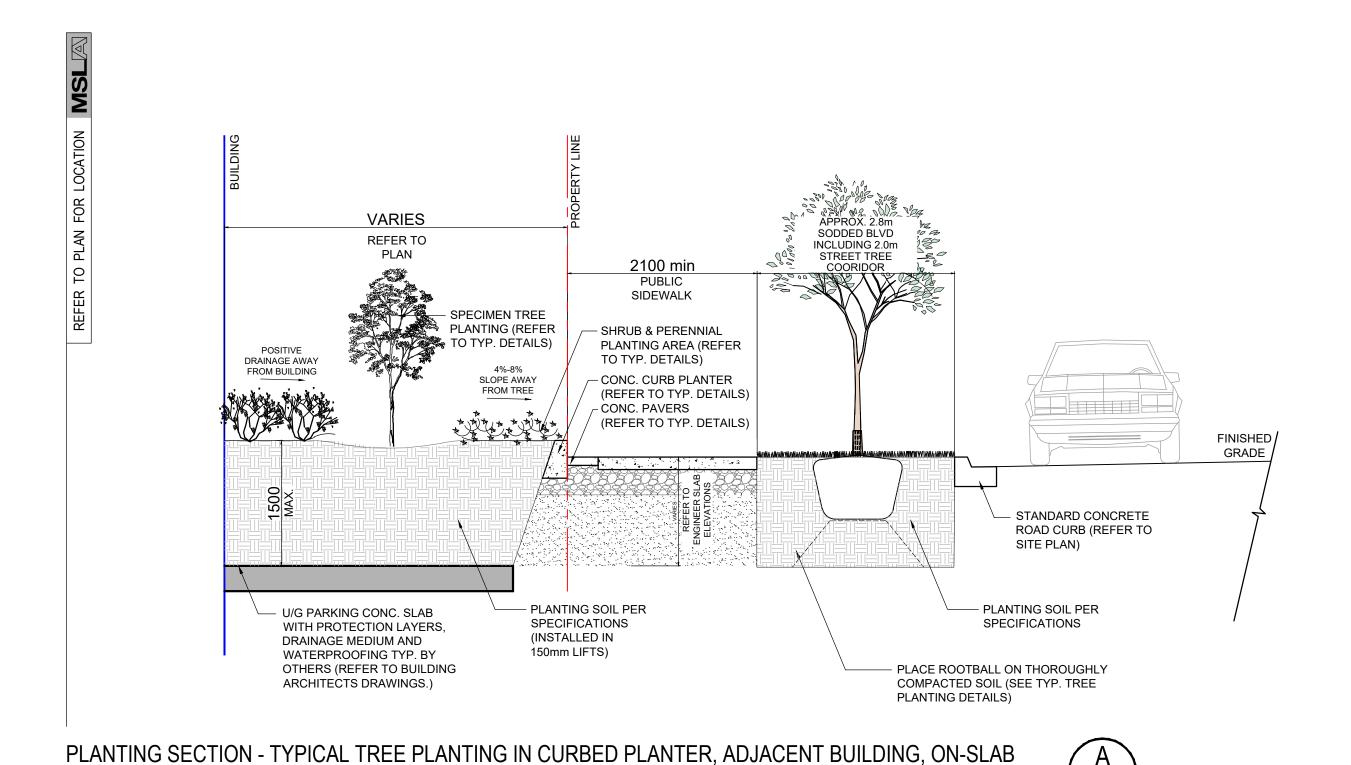

— DECIDUOUS TREE PLANTING (REFER TO TYP. DETAILS) PRIVATE WALKWAY — SHRUB & PERENNIAL PLANTING AREA (REFER TO TYP. DETAILS) SLOPE AWAY FROM TREE — CONC. CURB PLANTER (REFER TO TYP. DETAILS) POSITIVE DRAINAGE AWAY FROM BUILDING FINISHED GRADE STANDARD CONCRETE ROAD CURB (REFER TO SITE PLAN) — PLANTING SOIL PER SPECIFICATIONS U/G PARKING CONC. SLAB
 WITH PROTECTION LAYERS, (INSTALLED IN DRAINAGE MEDIUM AND 150mm LIFTS) WATERPROOFING TYP. BY PLACE ROOTBALL ON THOROUGHLY COMPACTED SOIL (SEE TYP. TREE OTHERS (REFER TO BUILDING ARCHITECTS DRAWINGS.) PLANTING DETAILS)

PLANTING SECTION - TYPICAL TREE PLANTING IN CURBED PLANTER, ON-SLAB

DECIDUOUS TREE PLANTING (REFER TO TYP. DETAILS) VARIES PRIVATE WALKWAY - SHRUB & PERENNIAL PLANTING AREA (REFER — CONC. CURB PLANT**E**R (REFER TO TYP. DETAILS) TO TYP. DETAILS) 4%-8% SLOPE AWAY POSITIVE DRAINAGE AWAY FROM BUILDING — CONCRETE SEATWALL (REFER TO TYP. DETAILS) FINISHED GRADE STANDARD CONCRETE 7 ROAD CURB (REFER TO / SITE PLAN) - PLANTING SOIL PER U/G PARKING CONC. SLAB SPECIFICATIONS WITH PROTECTION LAYERS, (INSTALLED IN DRAINAGE MEDIUM AND 150mm LIFTS) WATERPROOFING TYP. BY - PLACE ROOTBALL ON THOROUGHLY OTHERS (REFER TO BUILDING ARCHITECTS DRAWINGS.) COMPACTED SOIL (SEE TYP. TREE PLANTING DETAILS)

PLANTING SECTION - TYPICAL TREE PLANTING IN CURBED PLANTER, W/ SEATWALL, ON-SLAB

DATE:

MARTON SMITH LANDSCAPE ARCHITECTS

170 The Donway W Suite 206. Toronto, Ontario, Canada. M3C 2G3 tel. 416.492.9966 | email. info@msla.ca

Architect:

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Proposed Residential Development 69 & 117 John Street

Mississauga, Ontario

1:200 Date: **April 2023 D.R.** Checked By: **L.M.** Drawn By:

Drawing Title:

Draft Landscape Sections

Project No. Sheet No.

23120 LD-01