

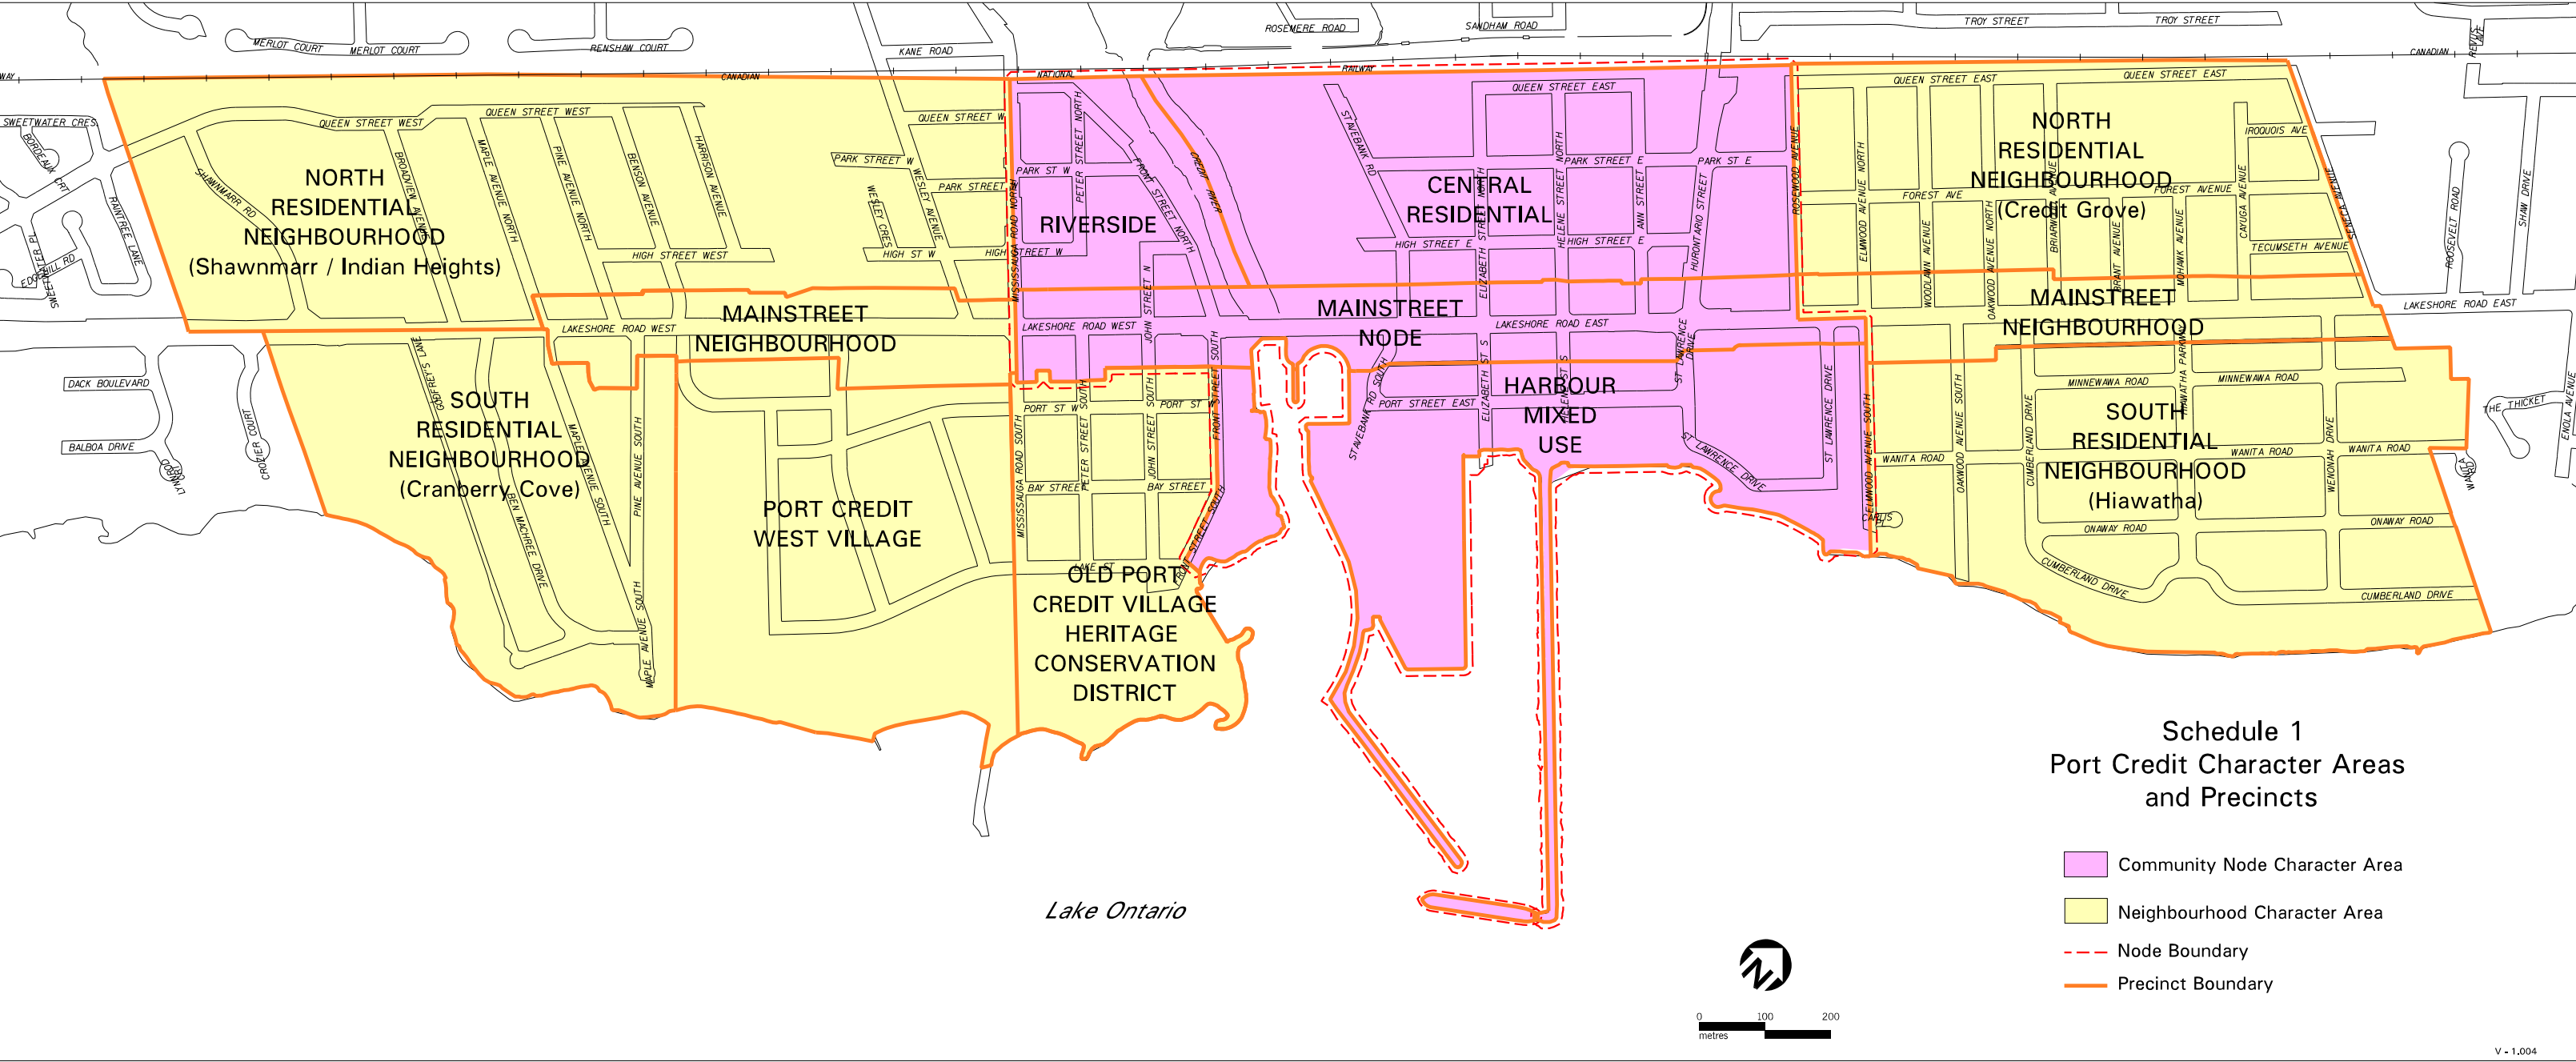


APPENDIX

A

Background Information

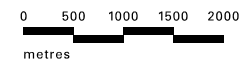

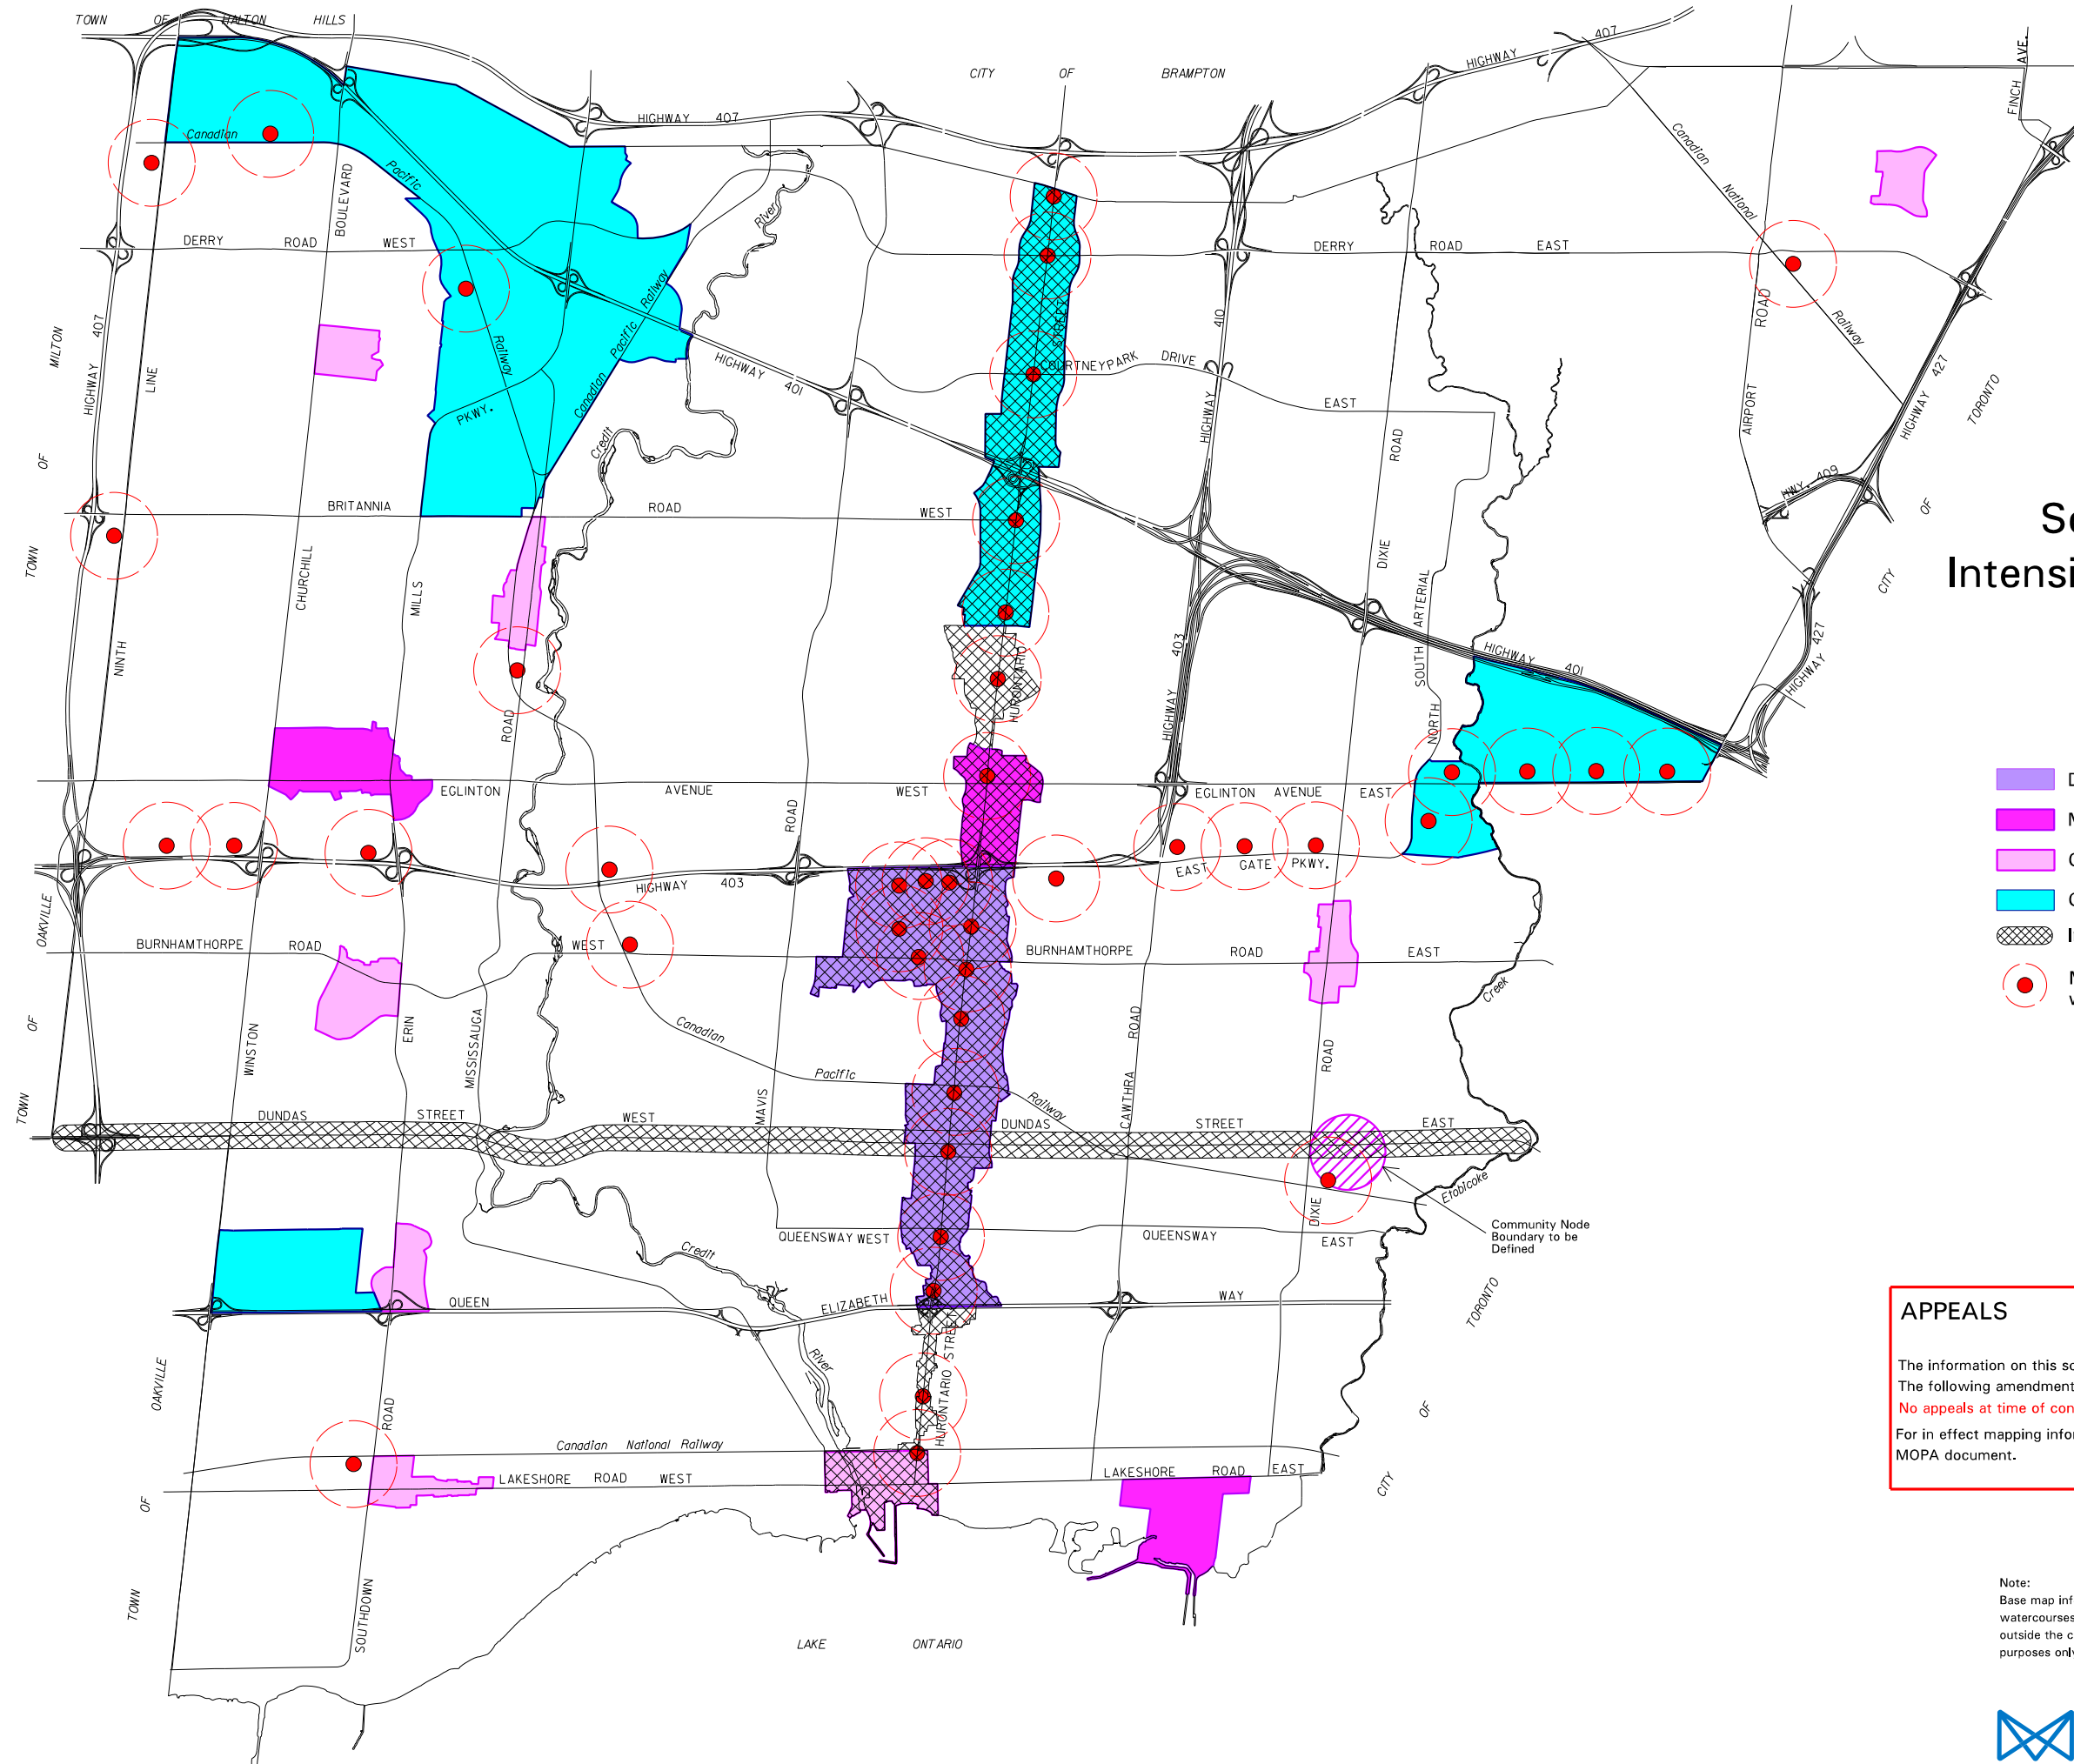

Schedule 2 Intensification Areas

- Downtown
- Major Node
- Community Node
- Corporate Centre
- Intensification Corridor
- Major Transit Station Area with 500m radius circle

APPEALS

The information on this schedule reflects Council adopted amendments. The following amendments are under appeal and effect this schedule:
No appeals at time of consolidation.
 For in effect mapping information refer to the Consolidation Tables and MOPA document.

Note:
 Base map information (e.g. roads, highways, railways, watercourses), including any lands or bodies of water outside the city boundaries, is shown for information purposes only.

REFER TO DWG. 302

KEY PLAN N.T.S.

LEGEND

- STORM SEWER AND MANHOLE
- EXISTING STORM SEWER AND MANHOLE
- FUTURE STORM SEWER AND MANHOLE
- EXISTING CONTOUR AND ELEVATION
- SINGLE/REARLOT CATCHBASIN
- DOUBLE CATCHBASIN
- LID STRUCTURE, AREA DRAIN & WEIR
(REFER TO LID PLANS 600's)
- HYDRANT & VALVE
- REGIONAL SERVICING BLOCK CORRIDOR
- VALVE AND BOX
- PROPOSED DRAINAGE AREA (ha) FOR MINOR SYSTEM (5 YEAR) FLOW
- PROPOSED RUNOFF COEFFICIENT
- EXISTING DRAINAGE AREA (ha) FOR MINOR SYSTEM (5 YEAR) FLOW
- EXISTING RUNOFF COEFFICIENT
- CATCHMENT ID
- ALLOWABLE RELEASE RATE
* APPLIES TO BLOCKS WHERE THE 100YR FLOWS ARE
CONTROLLED TO THE MINOR SYSTEM STORM CAPACITY,
MINOR SYSTEM DRAINAGE AREA BOUNDARY
- EXISTING MINOR SYSTEM DRAINAGE AREA BOUNDARY
- OVERLAND FLOW ROUTE
- EXISTING OVERLAND FLOW ROUTE
- EMERGENCY OVERLAND FLOW
- LIMIT OF SUBDIVISION
- LIMIT OF EXTERNAL WORKS

BENCHMARK NOTE

ON THE SOUTH FACE BETWEEN THE DOORS OF A RED BRICK FIRE STATION #104,
LOCATED AT 62 PORT STREET WEST, ON THE NORTH SIDE OF PORT STREET, 30m
EAST OF MISSISSAUGA ROAD.
ELEVATIONS ARE OF GEODETIC ORIGIN AND ARE DERIVED FROM THE CITY OF
MISSISSAUGA BENCHMARK NO. 731
ELEVATION = 81.25m
TOPOGRAPHIC SURVEY PREPARED BY J.D. BARNES LIMITED, MARCH 01, 2017.

| FIRST DATE | INTERIM DATE | SECOND DATE | FINAL DATE |
|---------------|---------------|---------------|------------|
| OCT. 30, 2019 | AUG. 21, 2020 | APR. 30, 2021 | |



URBANTECH® Consulting
A Division of Lighthouse-Zac Inc.
2030 Bristol Circle, Suite 108
Oakville, ON L6H 0H2
TEL: 905.828.8998 • urbantech.com


PORT CREDIT WEST VILLAGE PARTNERS L.P.
141 LAKESHORE ROAD EAST, MISSISSAUGA, ON L5G 1E8
70 MISSISSAUGA RD SOUTH
181 LAKESHORE RD WEST

Region of Peel
working with you



STORM DRAINAGE PLAN (PART 1 OF 2)

| | |
|---|--------------------------|
| REGION FILE No. 208,306 EXTERNAL WORKS | CITY FILE No. 21T-17004 |
| REGION FILE No. T-17004-1a INTERNAL WORKS | |
| SCALE: 1:1000 | AREA: 2-08-CS/D |
| PROJECT No. 16-489W | |
| DRAWN BY: S.A./A.G. | CHECKED BY: R.M./R.B.T.M |
| PLAN No. 301 | |
| DATE: AUGUST 2019 | SHEET OF C- |

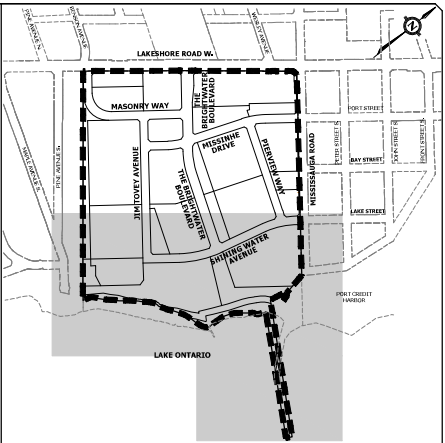

KEY PLAN
N.T.S.

LEGEND

- STORM SEWER AND MANHOLE
- EXISTING STORM SEWER AND MANHOLE
- FUTURE STORM SEWER AND MANHOLE
- EXISTING CONTOUR AND ELEVATION
- SINGLE/REARLOT CATCHBASIN
- DOUBLE CATCHBASIN
- LID STRUCTURE, AREA DRAIN & WEIR (REFER TO LID PLANS 600's)
- HYDRANT & VALVE
- REGIONAL SERVICING BLOCK CORRIDOR
- VALVE AND BOX
- PROPOSED DRAINAGE AREA (ha) FOR MINOR SYSTEM (5 YEAR) FLOW
- PROPOSED RUNOFF COEFFICIENT
- EXISTING DRAINAGE AREA (ha) FOR MINOR SYSTEM (5 YEAR) FLOW
- EXISTING RUNOFF COEFFICIENT
- CATCHMENT ID
- ALLOWABLE RELEASE RATE
- * APPLIES TO BLOCKS WHERE THE 100YR FLOWS ARE CONTROLLED TO THE MINOR SYSTEM STORM CAPACITY, MINOR SYSTEM DRAINAGE AREA BOUNDARY
- EXISTING MINOR SYSTEM DRAINAGE AREA BOUNDARY
- OVERLAND FLOW ROUTE
- EXISTING OVERLAND FLOW ROUTE
- EMERGENCY OVERLAND FLOW
- LIMIT OF SUBDIVISION
- LIMIT OF EXTERNAL WORKS

BENCHMARK NOTE
ON THE SOUTH FACE BETWEEN THE DOORS OF A RED BRICK FIRE STATION #104, LOCATED AT 62 PORT STREET WEST, ON THE NORTH SIDE OF PORT STREET, 30m EAST OF MISSISSAUGA ROAD.
ELEVATIONS ARE OF GEOIDETIC ORIGIN AND ARE DERIVED FROM THE CITY OF MISSISSAUGA BENCHMARK NO. 731
ELEVATION = 81.28m
TOPOGRAPHIC SURVEY PREPARED BY J.D. BARNES LIMITED, MARCH 01, 2017.

| FIRST DATE | INTERIM DATE | SECOND DATE | FINAL DATE |
|---------------|---------------|---------------|------------|
| OCT. 30, 2019 | AUG. 21, 2020 | APR. 30, 2021 | |



URBANTECH® Consulting
A Division of Leighton-Zac Inc. Ltd.
2030 Bristol Circle, Suite 108
Oakville, ON L6H 0H2
TEL. 905.828.8898 • urbantech.com

PORT CREDIT WEST VILLAGE PARTNERS L.P.
141 LAKESHORE ROAD EAST, MISSISSAUGA, ON L5G 1E8
70 MISSISSAUGA RD SOUTH
181 LAKESHORE RD WEST

Region of Peel
working with you



STORM DRAINAGE PLAN
(PART 2 OF 2)

| | |
|---|---------------------------|
| REGION FILE No. 208-306 EXTERNAL WORKS | CITY FILE No. 21T-17004 |
| REGION FILE No. T-17004-16 INTERNAL WORKS | |
| SCALE: 1:1000 | AREA: 2-08-CS/D |
| DRAWN BY: S.R./A.G. | CHECKED BY: R.M./R.B.T.M. |
| DATE: AUGUST 2019 | SHEET: OF |
| | PLAN No. 302 |