


TREE INVENTORY NOTES

Tree #	Common Name	Botanical Name	DBH (CM)	Condition	Comments	Recommendation
545	Ash Sp.	Fraxinus Sp.	14	F		Remove due to construction
546	Ash Sp.	Fraxinus Sp.	6	F	2 stem at base	Remove due to construction
547	Black Walnut	Juglans nigra	40	F	Minor deadwood in canopy	Retain
548	Manitoba Maple	Acer negundo	64	F	Minor deadwood in canopy	Retain
549	Common Buckthorn	Rhamnus cathartica	26	F	Minor to moderate deadwood in canopy	Remove due to construction
550	Common Buckthorn	Rhamnus cathartica	27	F	Multi-stem at base, minor to moderate deadwood throughout	Remove due to construction
551	Common Buckthorn	Rhamnus cathartica	15	F	Multi-stem at 0.7 metres, minor	Remove due to construction
552	Common Buckthorn	Rhamnus cathartica	27	F	Multi-stem at base, minor deadwood in canopy	Remove due to construction
553	Common Buckthorn	Rhamnus cathartica	21	F	Multi-stem at base, minor to moderate deadwood in canopy	Remove due to construction
554	Common Buckthorn	Rhamnus cathartica	20	F	Minor deadwood in canopy	Remove due to construction
555	Common Buckthorn	Rhamnus cathartica	21	F	Minor deadwood in canopy	Remove due to construction
556	Flowering Crabapple Tree	Malus Sp.	26	F	Mild lean, bow at top, minor deadwood in canopy	Remove due to construction
557	Flowering Crabapple Tree	Malus Sp.	31	FP	Multiple bows throughout, contorted form, moderate deadwood in canopy	Remove due to construction
558	Flowering Crabapple Tree	Malus Sp.	47	F	Mild lean, minor deadwood in canopy	Remove due to construction
O1	Black Walnut	Juglans nigra	~48	F	Minor deadwood in canopy	Retain
O2	Black Walnut	Juglans nigra	~26	F	Minor deadwood in canopy	Retain
O3	Black Walnut	Juglans nigra	~22	F	Minor to moderate deadwood in canopy	Retain
O4	Black Walnut	Juglans nigra	~33	F	Minor to moderate deadwood in canopy	Retain
O5	Black Walnut	Juglans nigra	~36	F	Minor to moderate deadwood in canopy	Retain

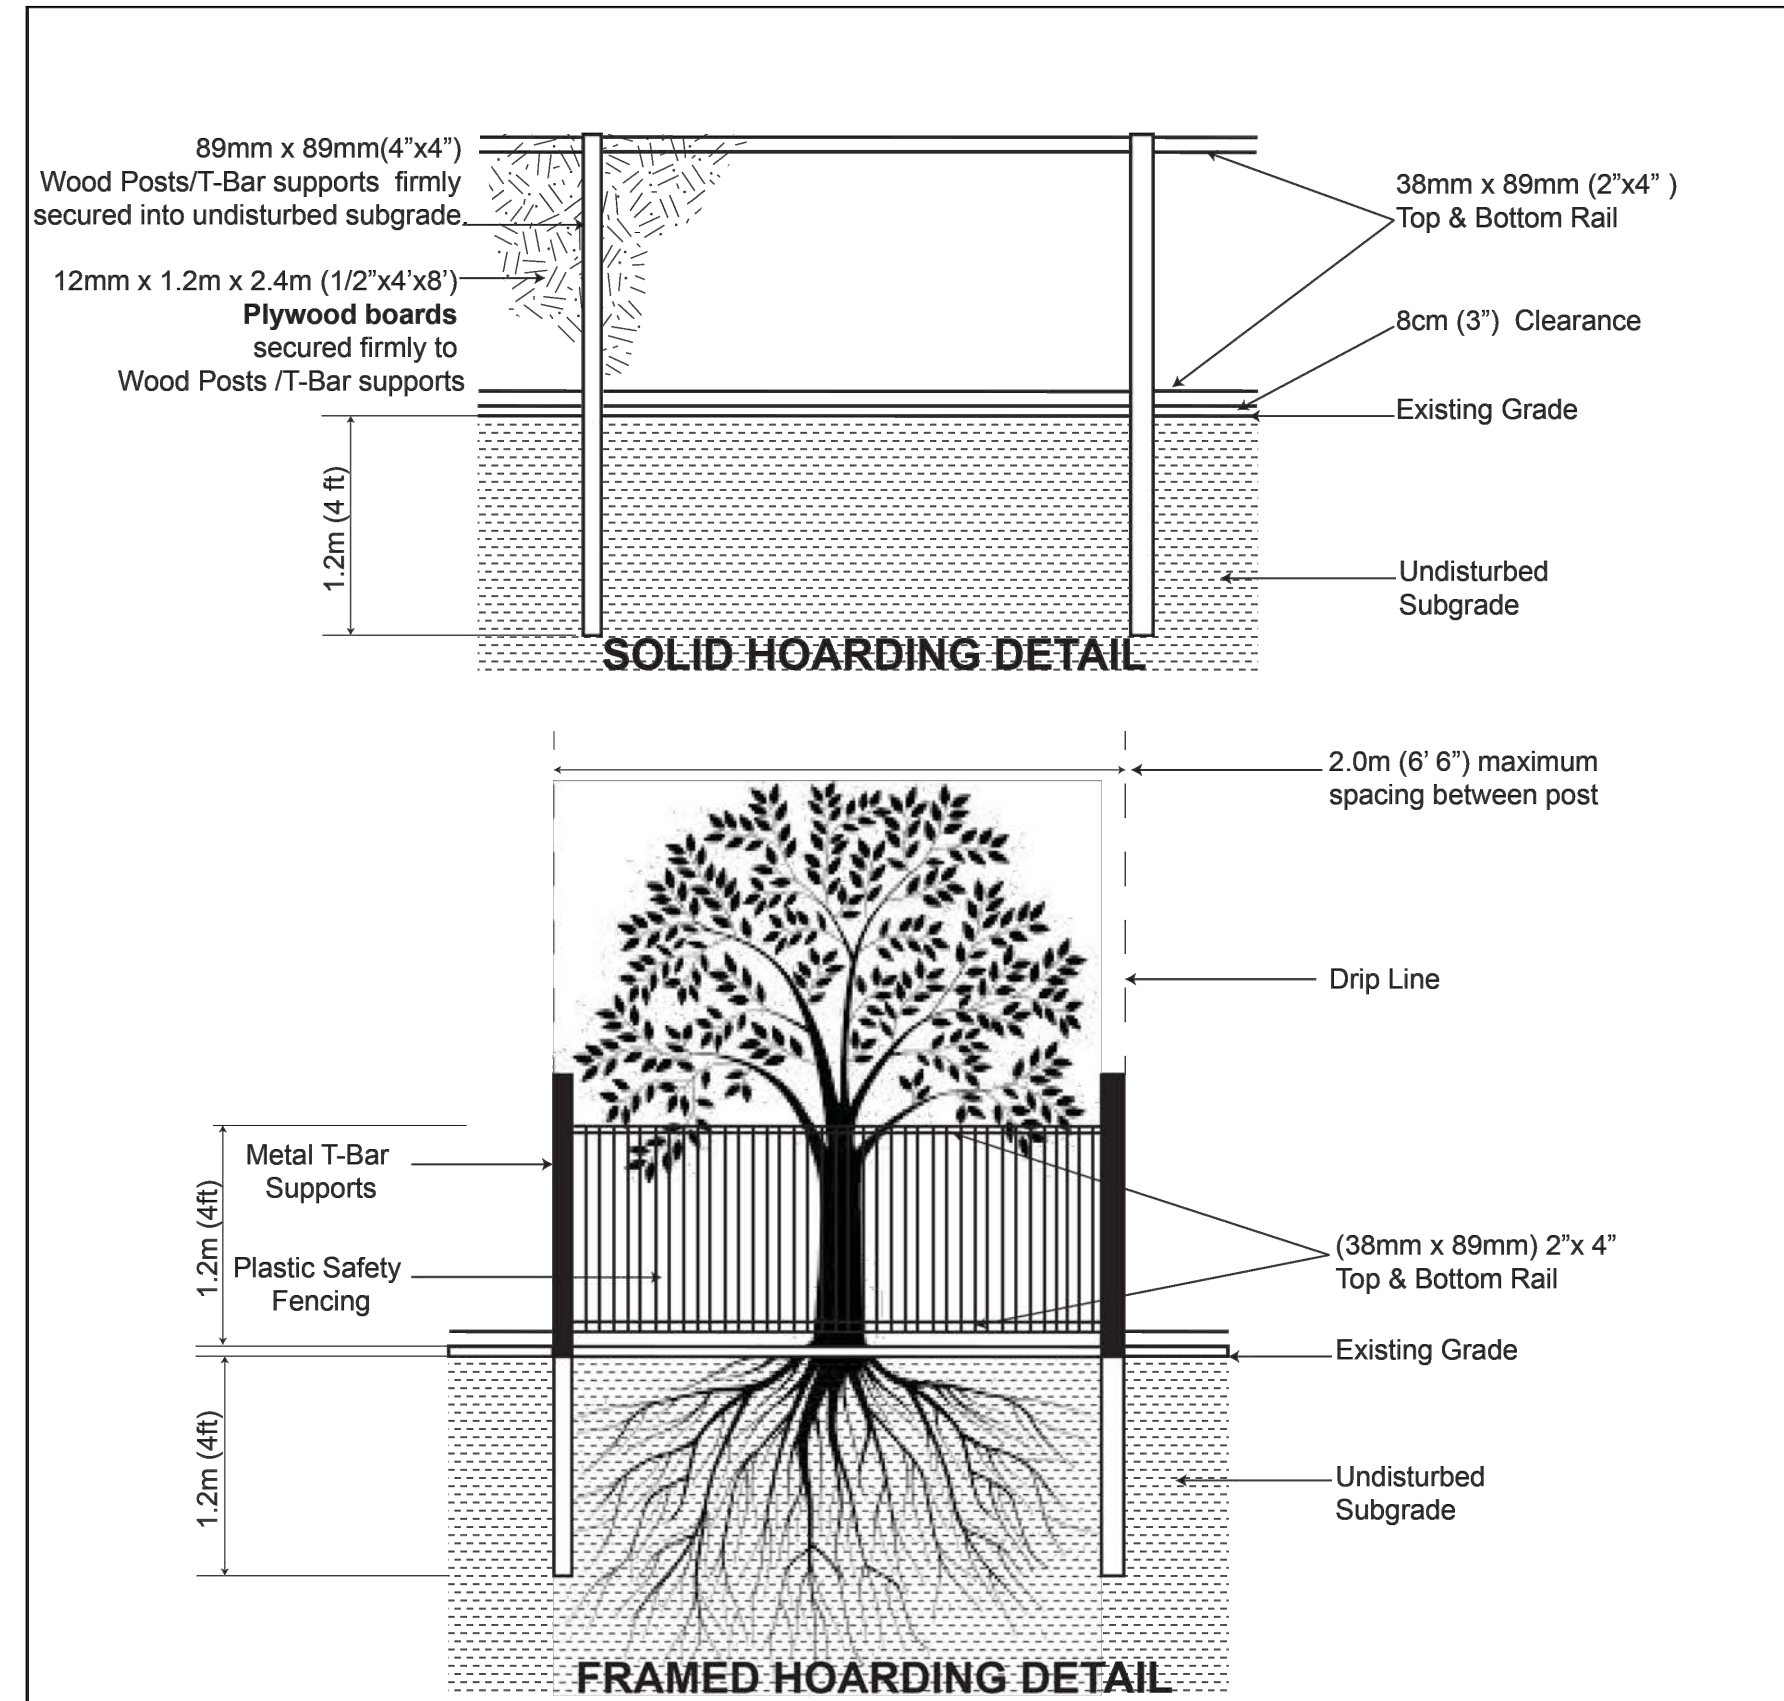

- NOTES:**
1. Hoarding details to be determined following initial site inspection.
 2. Private tree hoarding to be approved by Development & Design ; City tree hoarding to be approved by Community Services Dept.
 3. Hoarding must be supplied, installed and maintained by the applicant throughout all phases of construction. **Inspection must be conducted by the Development and Design Division prior to removing any/all private hoarding.**
 4. Do not allow water to collect and pond behind or within hoarding.
 5. **T-bar supports are acceptable alternative to 4x4 posts. U-shaped metal supports will not be accepted.**
 6. **Plywood** must be utilized for 'solid' hoarding. OSB/Chipboard will not be accepted for solid hoarding. Plywood sheets must be installed on "construction" side of frame.
 7. Applicant is responsible to ensure utility locates are completed within city boulevard prior to installing framed hoarding.

TREE PRESERVATION HOARDING



SCALE : N.T.S DATE : June 2017

1 TREE PROTECTION DETAIL
TI-6
CITY OF MISSISSAUGA STANDARD

Tree Protection Note:

The applicant is responsible for ensuring that tree protection hoarding is maintained throughout all phases of demolition and construction in the location and condition as approved by the Planning and Building Department. No materials (building materials, soil, etc.) may be stockpiled within the area of hoarding. Failure to maintain the hoarding as originally approved or the storage of materials within the hoarding will be cause for the Letter of Credit to be held for two years following completion of all site works. Hoarding must be inspected prior to the removal of any tree hoarding from the site.

Owner's Signature: _____


Date: _____

2 TREE PROTECTION NOTE
TI-6

LEGEND



KEY PLAN

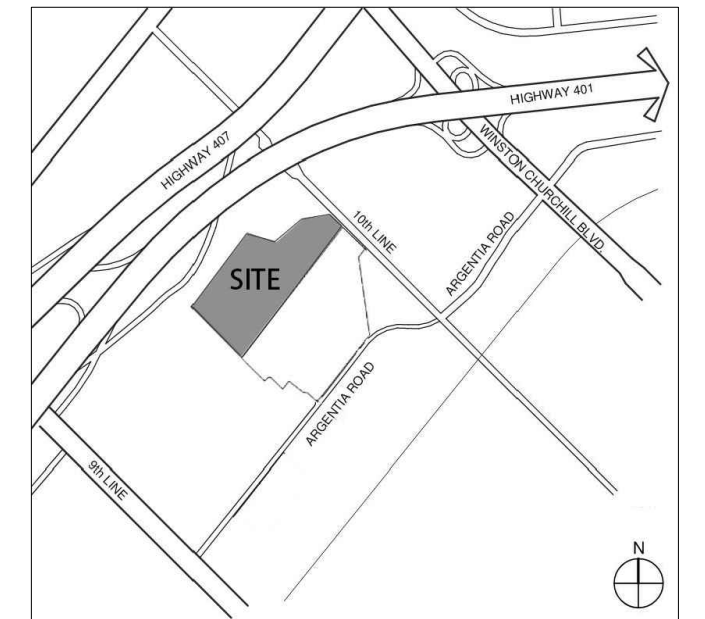

GENERAL NOTES

1. Do not scale the drawings. All dimensions are in millimetres unless noted otherwise.
2. This drawing is to be read in conjunction with the overall master plan and engineering drawings prepared by the project engineer and site plans prepared by the project architect.
3. The contractor shall check and verify all existing and proposed grading and conditions on the project and immediately report any discrepancies to the consultant before proceeding with any work.
4. The contractor is to be aware of all existing and proposed services and utilities. The contractor is responsible for having all underground services and utility lines staked by each agency having jurisdiction prior to commencing work.
5. This drawing is to be used for development approval only. For layout of all work refer to construction drawings.
6. Plant quantities indicated on the plan supercede the quantities from the plant list (report any discrepancies to the landscape architect).
7. Do not leave any holes open overnight.
8. Keep area outside construction zone clean and useable by others at all times. Contractor shall thoroughly clean areas surrounding the construction zone at the end of each work day.
9. Contractor to make good any and all damages outside of the development area that may occur as a result of construction at no extra cost.
10. This drawing is Copyright MHBC 2026.

REVISION NO.	DATE	ISSUED / REVISION	BY
2.	MARCH 4, 2026	ISSUED FOR SPA SUBMISSION	NV
1.	AUGUST 14, 2025	ISSUED FOR SPA	NV

MHBC PLANNING URBAN DESIGN & LANDSCAPE ARCHITECTURE
230-7050 WESTON ROAD WOODBRIDGE, ON, L4L 6G7 | P: 905.761.5588 F: 905.761.5589 | WWW.MHBCPLAN.COM

STAMP	DATE
<p>ISSUED FOR SPA ONLY NOT FOR CONSTRUCTION</p> <p><small>All drawings and specifications are instruments of service and will remain the property of MHBC Planning and must be returned at the completion of the work. This drawing shall not be used for construction purposes unless the drawings are marked 'Issued for Construction' and the professional seal is signed and dated by the landscape architect.</small></p>	MARCH 2026
	DRAWN BY
	PLAN SCALE
	FILE NO.
CHECKED BY	N.M.
OWNER	PROLOGIS 185 THE WEST MALL SUITE 700, TORONTO, ON

PROJECT	7564 TENTH LINE WEST MISSISSAUGA, ON
FILE NAME	TREE INVENTORY, PROTECTION, AND REMOVALS
DWG NO.	TI-6